### Advertisement for Bid Lee County, AL

Lee County is taking sealed bids for labor, equipment, materials, and any incidentals required to complete the work required for Project No. RALCP 41-146-24:

Intersection Improvements - Construction of a Roundabout at the Intersection of Lee Rd. 146 (Moore's Mill Road) and Lee Rd. 54 (Society Hill Road)

This bid is intended to comply with the Rebuild Alabama Act, Act No. 2019-2, as amended, and the Alabama Public Works Law, Alabama Code Title 39, as amended. Bidders shall be required to comply with the provisions of the Rebuild Alabama Act, Act No. 2019-2, as amended, and the Alabama Public Works Law, Alabama Code Title 39, as amended, regardless if the requirement is explicitly detailed in the bid proposal or not.

Ala. Code § 39-3-5 applies to this project. In accordance with Ala. Code § 39-3-5(a), ".... preference shall be given to resident contractors, and a nonresident bidder domiciled in a state having laws granting preference to local contractors shall be awarded Alabama public contracts only on the same basis as the nonresident bidder's state awards contracts to Alabama contractors bidding under similar circumstances; and resident contractors in Alabama, as defined in Section 392-12, be they corporate, individuals, or partnerships, are to be granted preference over nonresidents in awarding of contracts in the same manner and to the same extent as provided by the laws of the state of domicile of the nonresident."

As a condition for award, the business entity and its subcontractors shall not knowingly employ or hire an unauthorized alien within the State of Alabama. The awarded business entity must provide documentation of enrollment in the E-Verify program. The business must participate in the E-Verify program for the length of the contract. Bidders and material suppliers must be on the Alabama Dept. of Transportation's list of approved contractors and suppliers.

The Entire Project Shall Be Completed in Sixty-Five (65) Working Days.

Cashier's check or bid bond for 5% of bid (maximum - \$10,000.00) made payable to the Lee County Commission must accompany each bid as evidence of good faith. Bids will not be considered unless the bid bond form provided in the proposal is used.

The bracket range is shown only to provide general financial information to contractors and bonding companies concerning the project's complexity and size. This bracket should not be used in preparing a bid.

The bracket estimate for this project is from \$732,803.00 to \$895,648.00.

Sealed bids will be received by the Lee County Commission at 215 S. 9<sup>th</sup> Street, Opelika, AL 36801 or mailed to P.O. Box 2412, Opelika, AL 36803-2412 until 10:00 AM Central Time on 06/18/2025, and then publicly opened as soon thereafter as practicable. Award will be made at the next regularly scheduled meeting of the Lee County Commission.

Specifications are on file and may be acquired at the Lee County Engineering Department, 2555 Society Hill Road Opelika, Alabama 36804 Phone Number: (334) 737-7011 Lee County Engineering Department Hours of Operation are 6:00 A.M. to 4:30 P.M. (Central Time) from Monday through Thursday.

County reserves the right to accept or reject all Bids or any portion thereof.





### PROPOSAL NO. \_\_\_\_\_

, 20\_\_\_\_

#### FOR THE CONSTRUCTION OF LEE COUNTY PROJECT NO. RALCP 41-146-24

### LEE COUNTY, ALABAMA

Proposal of Contractor Name:
Of (City, State):
Alabama General Contractors License Number:
For constructing the Intersection Improvements – Construction of a Roundabout at the Intersection of Lee Rd. 146 (Moore's Mill Road) and Lee Rd. 54 (Society Hill Road).
The plans are composed of the drawings identified as follows: County Project No. RALCP 41-146-24
The specifications are hereto attached.
In order to be considered, sealed proposals must be received at the location and time below:
Lee County Commission 215 South 9 <sup>th</sup> Street Opelika, Alabama 36801 Phone: (334) 737-7011
<b>BEFORE: 10:00 AM ON JUNE 18, 2025</b> Bids will be opened as soon thereafter as practicable. Award will be made at the next regularly scheduled meeting of the Lee County Commission.

Bidder's Initials: \_\_\_\_\_ Page 1 of 23





#### **INSTRUCTIONS TO BIDDERS**

#### 1. <u>PREPARATIONS OF BIDS</u>:

Forms furnished, or copies thereof, shall be used, and strict compliance with the requirements of the invitation, these instructions, and the instructions printed on the forms is necessary. Special care should be exercised in the preparation of bids. Bidders must make their own estimates of the facilities and difficulties attending the performance of the proposed contract, including local conditions, uncertainty of weather, and all other contingencies. All designations and prices shall be fully and clearly set forth. The proper space in the bid and guaranty/bid bond forms shall be suitably filled in.

#### 2. LABOR AND MATERIALS NOT TO BE FURNISHED BY LEE COUNTY, ALABAMA:

The County Commission of Lee County, Alabama, will not furnish any labor, material, or supplies unless specifically provided in the Contract.

#### 3. <u>SIGNATURE TO BIDS</u>:

Each bid must give the full business address of the Bidder and must be signed by the Bidder with their usual signature. Bids by partnerships must furnish the full names of all partners and must be signed with the partnership name by one of the members of the partnership, or by an authorized representative, followed by the signature and designation of the person signing. Bids by corporations must be signed with the legal name of the corporation followed by the name of the State of Incorporation and by the signature and designation of the president, secretary, or other person authorized to bind it in the matter. The name of each person shall also be typed or printed below the signature. A bid by a person who affixes to this signature the word "president," "secretary," "agent," or other designation without disclosing his principal, may be held to be the bid of the individual signing. When requested by the County Commission of Lee County, Opelika, Alabama, satisfactory evidence of the authority of the officer signing on behalf of the corporation shall be furnished.

#### 4. <u>BIDS FOR ALL OR PART</u>:

Each project will be bid separately unless otherwise expressly requested in the Proposal. Combination bids, that are bids on separate projects lumped together as a single bid or on all or none bid or on all or none basis, will not be accepted unless the Proposal expressly requests or permits same.





#### 5. <u>ALTERNATE BIDS</u>:

Alternate bids will not be considered unless called for.

#### 6. <u>SPECIFICATIONS AND SCHEDULES</u>:

The specifications, conditions, schedules, and drawings which form the basis of any bid will be considered as a part thereof and will form a part of the Contract.

Copies of these papers, together with a copy of the standard contract form, including authorized additions, or deletions, if any, will be furnished to or made available for the inspection of bidders by the office indicated in the advertisement of invitation.

#### 7. <u>CORRECTIONS</u>:

Erasures, white-outs, or other changes in the bids must be initialed by the bidder.

#### 8. <u>OWNER</u>:

Where the word "Owner" appears herein, the same refers to Lee County, Alabama, and includes the County Commission of Lee County, its governing body.

#### 9. <u>GUARANTY, BONDS AND INSURANCE</u>:

Security is required to ensure the execution of Contract and for performance of the services, and no bid will be considered unless it is so guaranteed. The bidder must furnish with his bid a bid bond or cashier's check drawn on an Alabama bank in the amount of 5% of his bid price, but in no event more than ten thousand dollars (\$10,000.00) payable to Lee County Commission, of Lee County, Alabama. Cashier's check or bid bonds, will, at the option of the Owner, be paid into the funds of Lee County Commission as liquidated damages upon failure of the successful bidder to execute the written contract and furnish the performance bond, payment bond, and insurance coverages as hereinafter required, within fifteen (15) consecutive calendar days following written notice of the award of the Country, Alabama.





#### 10. <u>BONDS AND INSURANCE</u>:

The bonds and insurance policies of any surety company or insurance company respectively, authorized to do business in the State of Alabama, will be accepted as security and insurance as required for any bid or contract. See the instructions hereinafter contained and the applicable standard forms with respect to the type, form, and amounts of required bonds and insurance policies.

#### 11. <u>MARKING AND MAILING BIDS</u>:

Bids, with their guarantee, must be securely sealed in suitable envelopes, addressed, and marked on the outside "County Commission of Lee County, Bids for <u>RALCP 41-146-24</u> to be opened at <u>10:00 a.m. on June 18, 2025</u>" (Alabama General Contractor License Number and Name on envelope). Bids may be mailed to P.O. Box 2412, Opelika, AL 36803-2412.

#### 12. <u>TIME FOR RECEIVING BIDS</u>:

Bids received prior to the time of opening will be securely kept, unopened. The Owner will decide when the specified time has arrived, and no bid will be considered if received thereafter, except that when a bid arrives by mail after time for opening, but before award is made, and it is shown to the satisfaction of the Owner that the non-arrival on time was due solely to delay in the mails for which the bidder was not responsible, such bid may be received and considered. No responsibility will attach to Lee County or the County Commission for the premature opening of a bid not properly addressed or identified. Unless specifically authorized, telegraphic bids will not be considered, but modifications by telegraph of bids already submitted will be considered if received prior to the hour set for opening.

#### 13. <u>WITHDRAWAL OF BIDS</u>:

Bids may be withdrawn on written or telegraph request received from bidders prior to the time fixed for opening. Negligence on the part of the Bidder in preparing the bid confers no right for the withdrawal of the bid after it has been opened.

#### 14. <u>BIDDERS PRESENT</u>:

At the time fixed for the opening of bids, their contents will be made public for the information of bidders and others properly interested who may be present either in person or by representation.





#### 15. <u>AWARD OR REJECTION OF BIDS</u>:

The Contract will be awarded to the lowest responsive and responsible bidder complying with conditions of the invitation for bids, provided his bid is reasonable and it is in the interest of the Owner to accept it. The bidder to whom the award is made will be notified at the earliest possible date. The Owner, however, reserves the right to reject any and all bids and to waive any informality in bids received whenever such rejection or waiver is in the interest of the Owner. It also reserves the right to reject the bid of a bidder who has previously failed to perform properly or complete on time contracts of a similar nature, or a bid of a bidder who is not, in the judgment of the Owner, in a position to perform the Contract.

#### 16. <u>BIDDERS INTERESTED IN MORE THAN ONE BID:</u>

If more than one bid is offered by any one party, by or in a name of his clerk, partner, corporation in which he has a substantial interest, or in which he is an officer, or other person, all such bids may be rejected. A party who has quoted prices on materials to a bidder is not thereby disqualified from quoting prices to other bidders or from submitting a bid directly for the materials or work. The County Commission of Lee County reserves the right to determine in its discretion whether the provisions of this clause have been violated by any bidder.

#### 17. <u>ERRORS IN BIDS</u>:

Bidders or their authorized agents are expected to examine the maps, drawings, specifications, and all other instructions pertaining to the work, which will be open to their inspection. Failure to do so will be at the Bidder's own risk, and he cannot secure relief on the plea of error in the bid. In case of error in the extension of prices, the unit price will govern.

#### 18. <u>CONTRACT AND BOND</u>:

The bidder to whom award is made must, when requested, enter into written contract on the standard form as set out herein, with satisfactory security in the amount required, within the period specified, or, if no period be specified, within 15 days after the required forms are presented to him for signature.

#### 19. <u>COLLUSION</u>:

If there is any reason for believing that collusion exists among the Bidders any or all Proposals may be rejected, and those participating in such collusion may be barred from





submitting bids on the same or other work with the County.

#### 20. <u>SUBLETTING OR ASSIGNING OF CONTRACT</u>:

(a) <u>Limitations</u>. The Contractor shall not sublet, assign, transfer, convey, sell, or otherwise dispose of any portion of the contract, his right, title or interest therein, or his power to execute such contract, to any person, firm or corporation without written consent of the County, and such written consent shall not be construed to relieve the Contractor of any responsibility for the fulfillment of the contract. Unless otherwise stipulated in the proposal or special provisions, the Contractor shall perform with his own organization, and with the assistance of workmen under his immediate superintendence and reported on his payroll, all contract work of a value not less than 30 percent of the total contract amount, except that any items designated in the contract as "Specialty Items" so performed by subcontract may be deducted from the total contract amount before computing the amount of work required to be performed by the Contractor with his own organization.

(b) <u>Subcontractor's Status</u>: A Subcontractor shall be recognized only in the capacity of an employee or agent of the Contractor and the Contractor will be responsible to the County for all of the subcontractor's work, including failures or omissions; and his removal may be required by the Engineer, as in the case of an employee.

#### 21. <u>PROSECUTION OF WORK</u>:

(a) <u>Notice of Intent</u>: The Contractor shall give the Engineer definite notice of his intention to start work at least 72 hours in advance of beginning work and at least 24 hours in advance of beginning particular features of construction, such as driving piles, placing concrete, asphalt, etc. Should prosecution of the work be discontinued by the Contractor with the consent of the Engineer, the Contractor shall give the Engineer at least 48 hours' notice, in writing, before resuming operations.

(b) <u>General</u>: The Contractor shall prosecute the work continuously and diligently in the order and manner set out in his schedule as approved by the Engineer. He shall provide sufficient satisfactory materials, labor, and equipment to ensure that the work will be completed in a satisfactory manner within the time specified in the contract.

Should the Contractor fail to maintain a satisfactory rate of progress, the Engineer will require that additional forces and equipment be placed on the work to bring the project up to schedule and maintain it at that level.

Should the Contractor fail to furnish sufficient satisfactory equipment and labor for maintaining the quality and progress of the work at satisfactory level, the Engineer may withhold all estimates which are or may become due until satisfactory quality and progress are maintained; or the contract may be annulled.

Bidder's Initials: \_\_\_\_ Page 6 of 23





#### 22. <u>ASPHALT MATERIAL PRICE ADJUSTMENT:</u>

Price adjustments will be made to all Asphalt Materials in accordance with the following: It is understood and agreed that the price per ton of materials bid is based on prices at the time of opening of bids. Prices on contracts developed from this bid will be adjusted based on the PRICE INDEX per gallon of asphalt as determined by the ALDOT Asphalt Index for the month of June 2025. Any increase or decrease in asphalt prices will be determined and adjusted by the price index for the month in which delivery and placement is made. Adjustments will be made in accordance with the current ALDOT Specifications.

#### 23. <u>FINAL AUTHORITY</u>

The project shall be constructed under the instructions of the Lee County Engineer, which shall cover all phases of workmanship and materials, as final authority.





#### PROPOSAL FOR PROJECT NO. RALCP 41-146-24 LEE COUNTY, ALABAMA

#### TO: The County Commission of Lee County, Alabama

Dear Sirs:

The following proposal is made on behalf of \_\_\_\_\_\_ and no others. Evidence of authority to submit the proposal is herewith furnished. The proposal is made without collusion on the part of any person, firm, or corporation. This bid offering is intended to comply with the Rebuild Alabama Act, Act No. 2019-2, and Title 39 of the Alabama Code, 1975 edition as amended, the Alabama Public Works Law. Bidders shall be required to comply with the provisions of the Rebuild Alabama Act, Act No. 2019-02 and Title 39 of the Alabama Code regardless if the requirement is explicitly detailed in the bid proposal or not.

Sealed bids will be received by the Lee County Commission at 215 South 9<sup>th</sup> Street, Opelika, AL, 36801 until <u>10:00 AM Central Time on June 18, 2025</u>, and then publicly opened as soon thereafter as practicable. Award will be made at the next regularly scheduled meeting of the Lee County Commission.

This project is being advertised, let to contract, and administered by an awarding authority other than the Alabama Department of Transportation (ALDOT). All references made in the standard specifications and in other related and included documents of this proposal, to ALDOT (except as applies to references made to ALDOT considering a bidder to be disqualified from bidding, or to the awarding authority consulting or interacting with ALDOT, etc.), the "State", the "Department" or "Highway Department", etc. shall be understood to mean the awarding authority for this project.

The undersigned certifies that he or she has carefully examined the plans for this project and the specifications hereto attached including the special provisions and have also personally examined the site of work. On the basis of the specifications and plans the undersigned proposes to furnish all necessary machinery, tools, apparatus, and other means of construction, and do all the work and furnish all the material in the manner specified.

The undersigned further agrees to complete all the work in:

### Sixty-Five (65) Working Days

as defined in the most current revision of the Alabama Department of Transportation Standard Specifications. Each project shall designate the amount of working days or calendar days allowed. Should the undersigned fail to complete the project or projects awarded within the working days or calendar days stipulated, liquidated damages shall be assessed as defined in





section 108.10 in the current revision of the Alabama Department of Transportation Standard Specifications or as amended by Special Provision.

The undersigned understands that the quantities below are approximate only and are subject to either increase or decrease, and hereby propose to perform any increased or decreased quantities of work at the unit price bid. Additional working days shall be provided, as detailed herein, if additional work is required. The undersigned further understands and specifically agrees that in making this proposal, in case of error in the extension of prices in the bid, the unit price will govern.

By signing this contract, the contracting parties affirm, for the duration of the agreement, that they will not violate federal immigration law or knowingly employ, hire for employment, or continue to employ an unauthorized alien within the State of Alabama. Furthermore, a contracting party found to be in violation of this provision shall be deemed in breach of the agreement and shall be responsible for all damages resulting therefrom.

The undersigned further proposes to begin the work within fifteen (15) days of receiving the Proceed Order should he/she be awarded the bid and to complete the work within the time specified.

Enclosed is a cashier's check, drawn on an Alabama bank, or a bidder's bond, payable to Lee County, for an amount not less than five percent (5%) of the amount bid, but in no event more than ten thousand dollars (\$10,000.00), as a bid guaranty. The undersigned hereby agrees that in case of his/her failure to execute a Contract and furnish the Performance Bond, the Payment Bond, and a certificate of insurance coverage as specified within fifteen (15) days after notice of award, the awarding authority shall retain from the proposed guaranty if it be a cashier's check, or recover from the principal or the sureties if the guaranty be a bid bond, the difference between the amount of the contract as awarded and the full amount of the proposal of the next lowest responsible bidder. If no other bids are received, the full amount of the proposal guaranty shall be so retained or recovered as liquidated damages for such default. It is understood that in case the work is not awarded to the undersigned, the check will be returned as provided in the Specifications hereto attached. The bidder's bond shall be prepared on the form attached to this proposal and issued by a surety company authorized to do business in the State of Alabama.

Upon notification of award of the bid, the undersigned, within fifteen (15) days, proposes to furnish a Performance Bond equal to 100% of the total amount of the bid and a Payment Bond equal to 50% of the total amount of the bid to Lee County. The undersigned also proposes to furnish a certificate of insurance coverage in the amounts specified in this proposal.





The undersigned shall submit the Advertisement of Project Completion to Lee County immediately following the completion and acceptance of all work required. The County Engineer will submit the advertisement to the Association of County Commissions of Alabama (ACCA) to be posted on a website maintained by ACCA for a period of four consecutive weeks.

The undersigned shall give notice of the project completion by advertising for four consecutive weeks in a newspaper of general circulation published within the city of county where the work has been performed.

Upon completion and acceptance of all work required, the undersigned will be paid upon presentation of the following:

- a. A properly executed and duly certified voucher for final payment.
- b. A release of all claims and claims of liens against the awarding authority arising by virtue of the contract.
- c. Proof of Advertisement of project completion (AL Code 39-1-1(f) requires a 30 day waiting period after the notice has run before final settlement can be made)

The undersigned agrees: Final payment will be made within 35 days after all the above requirements are met; Partial Payments, to be paid no more than monthly, will be provided under this contract; Retainage shall be withheld as required under Code of Alabama Section 39-2-12.





#### BID ITEMS PROJECT NO: RALCP 41-146-24

The following items shall be constructed in accordance with the Alabama Department of Transportation Standard Specifications for Highway Construction, most current edition, except as modified herein.

#### NOTES:

- 1. All contractors and material suppliers shall be listed on ALDOT's list of approved contractors and suppliers.
- 2. The following unit prices shall include all labor, materials, equipment, equipment rental, overhead, profit, insurance, etc., to cover the finished work of the several kinds called for.
- 3. Bidder understands that the Owner reserves the right to reject any and all bids.
- 4. Use of asphalt shingles shall <u>NOT</u> be allowed in the bituminous concrete wearing surface layer. Submittal of a job mix formula for all asphalt pay items and approval by the Lee County Engineer, prior to beginning paving operations, shall be required.
- 5. All Quality Control aspects for Hot Mix Asphalt Pavement shall be the responsibility of the Contractor. Quality Assurance of the bituminous concrete wearing surface layer shall be the responsibility of the Lee County Highway Department and accomplished by conducting assurance/verification testing, on a random basis, of independent samples obtained by a third party employed by Lee County, at a frequency of one or more per day, as determined necessary by the Lee County Engineer. Acceptance of the mixture shall be in accordance with the most current edition of the ALDOT Standard Specifications for Highway Construction.

### SEE FOLLOWING PAGES





ITEM NO.	DESCRIPTION	UNITS	QUANTITY	UNIT COST	BID AMOUNT
206D-000	REMOVING PIPE	LINEAR FT.	32		
210A-000	UNCLASSIFIED EXCAVATION	CUBIC YD.	300		
210A-001	UNCLASSIFIED EXCAVATION (SPECIAL UNDERCUTTING)	CUBIC YD.	300		
210D-021	BORROW EXCAVATION (LOOSE TRUCKBED MEASUREMENT)(A4 OR BETTER)	CUBIC YD.	600		
214A-000	STRUCTURE EXCAVATION	CUBIC YD.	65		
230A-000	ROADBED PROCESSING	ROADBED STATION	5		
231B-004	ROADBED STABILIZING MATERIAL, ALDOT #57	TON	300		
301A-012	CRUSHED AGGREGATE BASE COURSE, TYPE B, PLANT MIXED, 6" COMPACTED THICKNESS	SQ. YD.	1,618		
305B-071	COURSE AGGREGATE, SECTION 801, FOR MISCELLANEOUS USE	TON	200		
405A-000	TACK COAT	GALLON	365		
408A-052	PLANING EXISTING PAVEMENT (APPROX. 2.0" THRU 8.0")	SQ. YD.	212		
424A-360	SUPERPAVE BITUMINOUS CONCRETE WEARING SURFACE LAYER, 1/2" MAX. AGGREGATE SIZE MIX, ESAL RANGE C/D	TON	646		
424B-658	SUPERPAVE BITUMINOUS CONCRETE UPPER BINDER LAYER, LEVELING, 3/4" MAX. AGGREGATE SIZE MIX, ESAL RANGE C/D	TON	202		





ITEM NO.	DESCRIPTION	UNITS	QUANTITY	UNIT COST	BID AMOUNT
424B-692	SUPERPAVE BITUMINOUS CONCRETE LOWER BINDER LAYER, WIDENING, 1" MAX. AGGREGATE SIZE MIX ESAL RANGE C/D	TON	245		
430B-043	AGGREGATE SURFACING (1" DOWN, CRUSHER RUN)	TON	150		
450A-022	PLAIN CEMENT CONCRETE PAVEMENT, 14 INCHES THICK	SQ. YD.	99		
535A-078	15" SIDE DRAIN PIPE (CLASS 3 R.C.)	LINEAR FT.	232		
600A-000	MOBILIZATION	LUMP SUM	1		
614A-000	SLOPE PAVING	CUBIC YD.	48		
614B-000	REINFORCED SLOPE PAVING (TRUCK APRON)	CUBIC YD.	79		
623B-001	CONCRETE CURB, TYPE N SPECIAL	LINEAR FT.	162		
623B-121	CONCRETE CURB, TYPE A (MODIFIED)	LINEAR FT.	110		
623B-008	CONCRETE CURB, TYPE H (MODIFIED)	LINEAR FT.	239		
623C-003	COMBINATION CURB AND GUTTER, TYPE C (MODIFIED)	LINEAR FT.	1,060		
641S-500	VALVE BOX RESET	EACH	10		
650B-000	TOPSOIL FROM STOCKPILES	CUBIC YD.	66		
652A-100	SEEDING	ACRE	2		
656A-010	MULCHING	ACRE	2		
659C-004	EROSION CONTROL PRODUCT, TYPE C2	SQ. YD.	560		
665J-002	SILT FENCE	LINEAR FT.	200		
6650-001	SILT FENCE REMOVAL	LINEAR FT.	200		
665Q-002	WATTLE	LINEAR FT.	200		
680A-001	GEOMETRIC CONTROLS	LUMP SUM	1		





ITEM NO.	DESCRIPTION	UNITS	QUANTITY	UNIT COST	BID AMOUNT
701G-253	SOLID WHITE, CLASS 2, TYPE A TRAFFIC STRIPE (5" WIDE)	LINEAR FT.	2,900		
701G-265	SOLID YELLOW, CLASS 2, TYPE A TRAFFIC STRIPE (5" WIDE)	LINEAR FT.	3,650		
701A-270	SOLID WHITE, CLASS 2, TYPE A TRAFFIC STRIPE (10" WIDE)	MILE	1		
701B-065	DOTTED CLASS 2, TYPE A TRAFFIC STRIPE (ROUNDABOUT 10" WIDE)	LINEAR FT.	150		
701C-001	SOLID TEMPORARY TRAFFIC STRIPE	MILE	2		
701H-001	SOLID TRAFFIC STRIPE REMOVE (PLASTIC)	LINEAR FT.	2,100		
703A-002	TRAFFIC CONTROL MARKINGS, CLASS 2, TYPE A	SQ. FT.	1,300		
703C-001	REMOVAL OF EXISTING TRAFFIC CONTROL MARKINGS OR LEGENDS (PLASTIC)	SQ. FT.	150		
703D-001	TEMPORARY TRAFFIC CONTROL MARKINGS	SQ. FT.	1,500		
705A-030	PAVEMENT MARKERS, CLASS A- H, TYPE 2-C	EACH	95		
705A-032	PAVEMENT MARKERS, CLASS A- H, TYPE 1-B	EACH	260		
705A-037	PAVEMENT MARKERS, CLASS A- H, TYPE 2-D	EACH	15		
705A-038	PAVEMENT MARKERS, CLASS A- H, TYPE 2-E	EACH	150		
710A-163	CLASS 10 ALUMINUM FLAT SIGN PANELS (TYPE XI BACKGROUND)	SQ. FT.	28		
710A-171	CLASS 4, ALUMINUM FLAT SIGN PANELS (TYPE IV BACKGROUND)	SQ. FT.	195		





ITEM NO.	DESCRIPTION	UNITS	QUANTITY	UNIT COST	BID AMOUNT
710B-001	ROADWAY SIGN POST (#3 "U"	LINEAR FT.	244		
/100-001	CHANNEL GALVANIZED STEEL)	LINEAR FT.	244		
7100 000	REMOVAL OF EXISTING	KISTING	1		
710C-000	ROADWAY SIGNS	LUMP SUM	1		
740B-000	CONSTRUCTION SIGNS	SQ. FT.	560		
740D-000	CHANNELIZING DRUMS	EACH	150		
740E-000	CONES (36 INCHES HIGH)	EACH	200		
7400-000	PILOT CAR	EACH	1		
7404 001	PORTABLE CHANGEABLE		4		
742A-001	MESSAGE SIGN, TYPE 2	EACH	4		

#### TOTAL

### THIS AREA INTENTIONALLY LEFT BLANK





The undersigned hereby states that this Bid Proposal is to the best of their knowledge; their true and correct bid, except for changes initiated herein, and is submitting these bid items for review and consideration.

Signature of Bidder (If Firm or Individual)	
By:	
Address of Bidder	
Name and Address of Member of Firm	
***************************************	****
Signature of Bidder (Corporation)	
Print Name:	
Business Address	
Signature of President	
Print Name:	
Business Address	
Signature of Secy. & Treas.	
Print Name:	
Attest: Incorporated in	
State (Corporate Seal)	





#### BIDS WILL NOT BE CONSIDERED UNLESS THIS FORM FOR BID BOND IS USED AND IS SIGNED IN INK BY PRINCIPAL AND SURETY.

#### **BID BOND**

#### KNOW ALL MEN BY THESE PRESENTS:

That		of
	(Name of Contractor)	
	(Address)	
as Principal, and		of
1	(Name of Surety)	
	-	, as Surety,
	(Address)	5

are held firmly bound unto LEE COUNTY COMMISSION, a Political Subdivision of and Body Corporate in the State of Alabama as Obligee, in the full and just sum of <u>FIVE PERCENT</u> (5%) OF AMOUNT BID (Maximum Amount of Bond \$10,000), lawful money of the United States, for the payment of which sum, well and truly to be made, we bind ourselves, our heirs, executors, administrators, successors and assigns, jointly and severally, firmly by these presents.

WHEREAS, the said Principal is herewith submitting its proposal for

### RALCP 41-146-24

The condition of this obligation is such that if the aforesaid Principal shall be awarded the contract the said Principal will, within the time required, enter into a formal contract and give a good and sufficient bond to secure the performance of the terms of and conditions of the Contract, then this obligation to be void; otherwise, the Principal and the Surety will pay unto the Obligee the difference in money between the amount of the Contract as awarded and the amount of the proposal of the next lowest responsible bidder, which amount shall not exceed \$10,000. If no other bids are received, the full amount of the proposal guarantee shall be so retained or recovered as liquidated damages for such default.

Witness our hands and seals this \_\_\_\_\_ day of \_\_\_\_\_, 20\_\_\_\_.

Signature of Individual Bidder: (Use only where bidder is an individual)

\_\_\_\_\_, Doing business as \_\_\_\_\_

(Name of Individual)

(Business Name)

Business Mailing Address: \_\_\_\_\_

(Mailing Address)





Page 2 of 2 Bid Bond Project <u>RALCP 41-146-24</u>

#### Name of Corporation, Partnership, or Joint Venture:

	ship, Joint Venture or Corporation	n)
Business Mailing Address:	RV.	
Address	DY: DY: (Signa	(L.S.) ature and Position or Title of Officer
	Autho	orized to Sign Bids and Contracts for Firm)
(2	Address)	
Business Mailing		
Address:		(L.S.) ture and Position or Title of Officer
		orized to Sign Bids and Contracts for Firm)
	Address)	-
Business Mailing Address:	BV·	(IS)
	BT (Signa	(L.S.) ture and Position or Title of Officer
	Authors) Authors	orized to Sign Bids and Contracts for Firm)
(2	Address)	
(Corporate Seal)		of State under the laws of which the
Attest:	Corpo	ration was chartered:
(Secretary)		(State)
(Corporate Seal)	Name	of State under the laws of which the
Attest:		ration was chartered:
(Secretary)		(State)
	SUPETV	
	JUKEI I.	(Name of Surety)
	BY (AGENT):	(Attorney in Fact)
	AGENT'S ADDRESS:	
		(Mailing Address)
NOTICE: Valid Power of Attorney	v Must Be Attached.	(maning maness)

Bidder's Initials: \_\_\_\_\_ Page **18** of **23** 





#### **INSURANCE REQUIREMENTS**

The Contractor, at its sole expense, shall obtain and maintain in full force the following insurance to protect the Contractor and the County Commission of Lee County, Alabama at limits and coverages specified below. These limits and coverages specified are the minimum to be maintained and are not intended to represent the correct insurance needed to fully and adequately protect the Contractor. The requirements shown for "large projects" are for those projects whose bid are greater than or equal to \$250,000. The requirements shown for "small projects" are for those with bids less than \$250,000.

All insurance will be provided by insurers licensed to conduct business in the State of Alabama and shall have a minimum A.M. Best rating of A- VII and must be acceptable to the County Commission of Lee County, Alabama. Self-insured plans and/or group funds not having an A.M. Best rating must be submitted to the County Commission of Lee County, Alabama for prior approval.

No work shall be performed until proof of compliance with the insurance requirements has been received by the County Commission of Lee County, Alabama.

#### (a) <u>Worker's Compensation and Employers Liability</u>

Part One:	Statutory Benefits as required by the State of Alabama				
Part Two:	Employers Liability	Large <u>Projects</u>	Small <u>Projects</u>		
Each Accident Each Employee Policy Limit		\$3,000,000 \$3,000,000 \$3,000,000	\$1,000,000 \$1,000,000 \$1,000,000		

- U. S. Longshoremen & Harborworkers' Act (USL&H) Required if contract involves work near a navigable waterway that may be subject to the USL&H law.
- Maritime Endorsement (Jones Act) Endorsement required if contract involves the use of a Vessel. Or include coverage for "Master or Members or Crew" under "Protection and Indemnity" coverage





Insurance Requirements Page 2 of 4

	Large	Small
	Projects	Projects
Bodily Injury by accident	\$3,000,000	\$1,000,000
(Each Accident)		
Bodily Injury by disease	\$3,000,000	\$1,000,000
(Aggregate)		

#### (b) **Commercial General Liability**

Coverage on an Occurrence form with a combined single limit (Bodily Injury and Property Damage combined) as follows:

	Large <u>Projects</u>	Small <u>Projects</u>
Each Occurrence	\$3,000,000	\$1,000,000
Personal and Advertising Injury	\$3,000,000	\$1,000,000
Products/completed	\$3,000,000	\$1,000,000
Operation Aggregate		
General Aggregate	\$3,000,000	\$1,000,000

- Coverage to include:
  - Premises and operations
  - Personal Injury and Advertising Injury
  - Independent Contractors
  - Blanket Contractual Liability
  - Explosion, Collapse and Underground hazards
  - Broad Form Property Damage
  - Products/Completed Operations This shall remain in effect for 24 months beyond completion and acceptance by owner of the project, whichever is later.
  - Railroad Protective Liability Insurance if work involves construction, demolition or maintenance operations on or within 50 feet of a railroad.
- The contractor shall name the County Commission of Lee County, Alabama, its officers, appointees, employees, and agents as additional insured for claims arising out of the Contractors and/or Subcontractors work. The ISO Form CG 20 10 11 85 or a comparable form that is no more restrictive shall be required. The Additional Insured form MUST include





Insurance Requirements Page 3 of 4

the current Operations and Products/Completed Operations of the contractor. The naming of the additional insured does not obligate the additional insured to pay any premiums due.

- Aggregate limits to be on a "per project" basis OR an Owners and Contractors Protective Liability Policy shall be provided in the name of County Commission of Lee County, Alabama, the contractor and Subcontractors. Limits to be the same as above Commercial General Liability.

### (c) <u>Automobile Liability</u>

Covering all Owned, Non-Owned, and Hired vehicles with a Combined single limit (bodily injury and property damage combined) of \$3,000,000 each accident for **large** projects and \$1,000,000 for **small** projects. The policy shall name the County Commission of Lee County, Alabama its officers, appointees, employees, and agents as an Additional Insured.

#### (d) Protection and Indemnity Insurance

If the contract involves work aboard an Owned, Non-Owned or Hired Vessel, Liability coverage in the amount of \$3,000,000 per occurrence shall be maintained.

#### (e) Indemnification and Liability

Under this section the term County shall include Lee County, the Lee County Commission, the officers, appointees, department heads, agents, and employees of the Lee County Commission.

The County shall not be liable for any injury to the person or property of any person, firm, or corporation resulting directly or indirectly from Contractor's performance of this Contract, and the Contractor assumes full and complete responsibility therefore.

The Contractor shall further indemnify the County and hold the County safe and harmless from any and all liability, lawsuits, judgments, attorney fees, and other costs incurred by the County in defending any claim or lawsuit made against the

Bidder's Initials: \_\_\_\_ Page **21** of **23** 





Insurance Requirements Page 4 of 4

County by any person, firm, or corporation arising directly or indirectly out of any work performed by the Contractor pursuant hereto or any breach or alleged breach of duty or responsibility of the Contractor related thereto.

#### Waiver of Subrogation

The Workers Compensation Policy shall contain a Waiver of Subrogation in favor of the County Commission of Lee County, Alabama, its officers, appointees, employees, and agents.

#### **Certificate of Insurance**


A Certificate of Insurance evidencing the above minimum requirements must be provided to and accepted by the County Commission of Lee County, Alabama PRIOR to commencement of any work on the contract. Each policy shall be endorsed by the issuing insurer to provide thirty (30) days prior written notice of cancellation to the County Commission of Lee County, Alabama.





# END OF PROPOSAL

Bidder's Initials: \_\_\_\_\_ Page **23** of **23** 

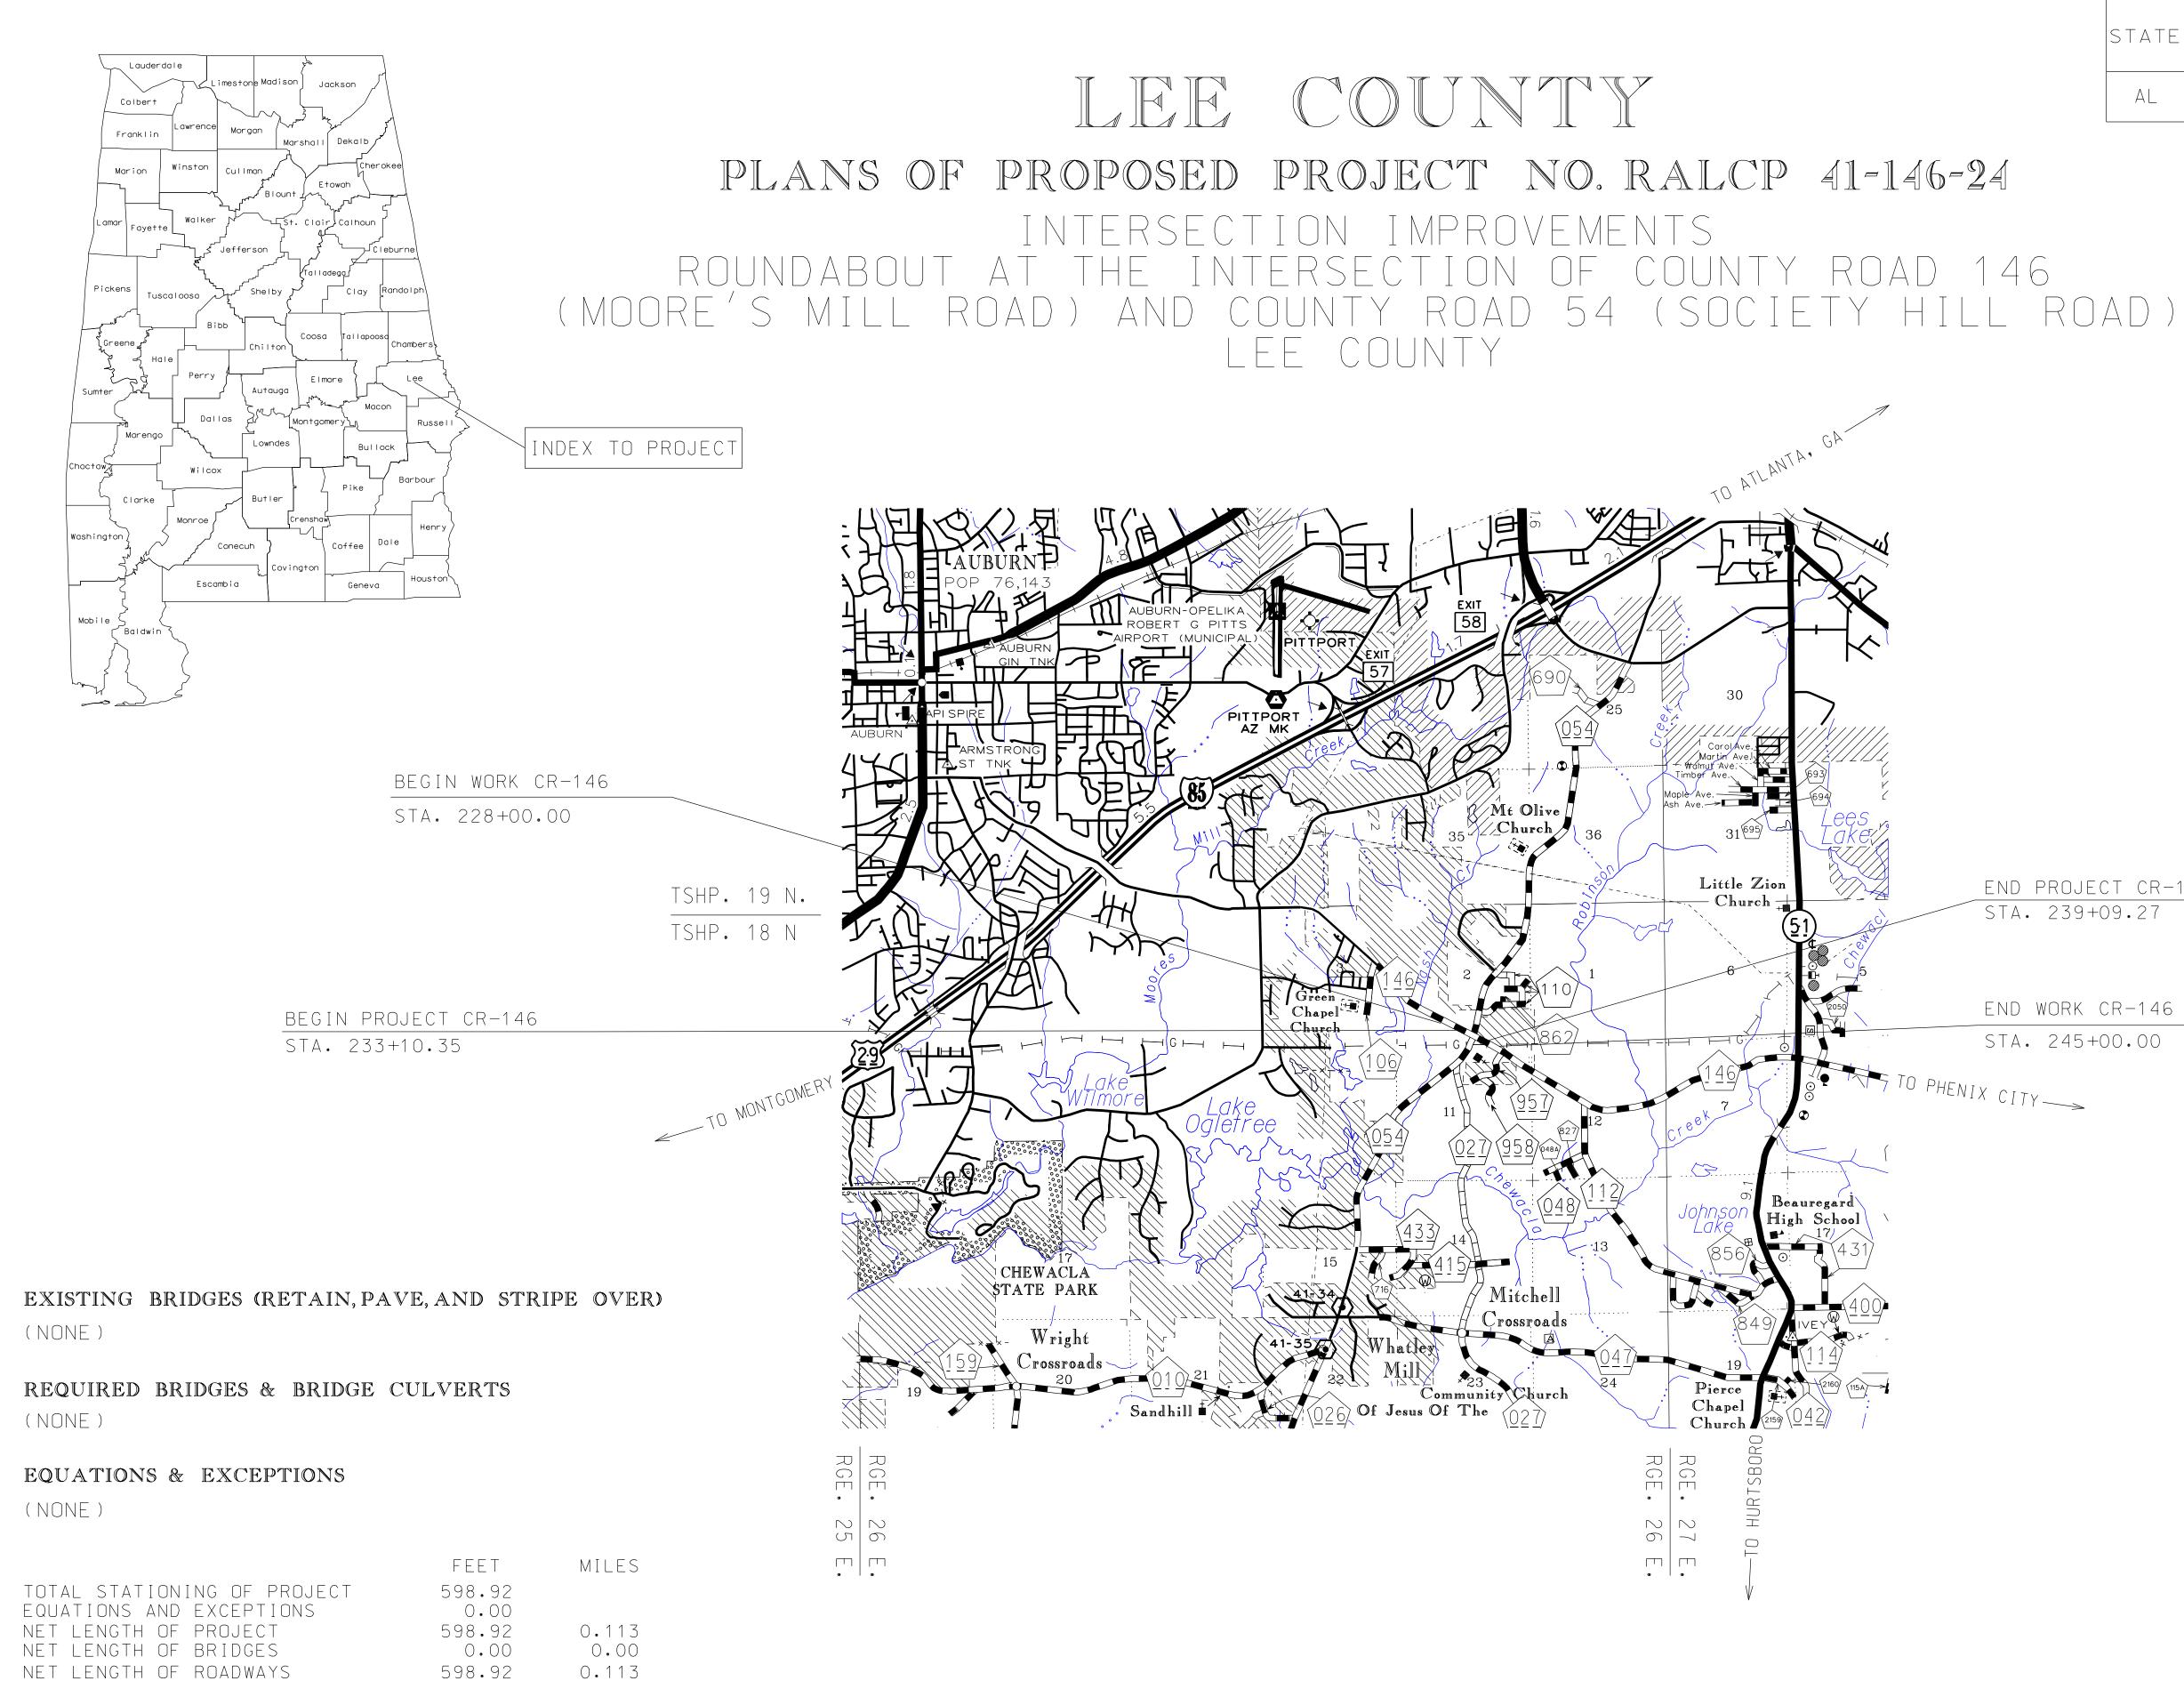

STATE	REFERENCE Project no.	FISCAL YEAR	SHEET NO.	LAST Sheet NO.
AL	RALCP 41-146-24	2025	1	10G

Design Designation	
ADT ( 2025 ) ADT ( 2035 ) K D	3,455 - 8,446 4,211 - 10,296
TDHV TADT	2%
V ( Design Speed ) Min. Stopping Sight Dist.	25 MPH 155 (FT)
These plans have been pre	pared to conform

These plans have been prepared to conform with the Alabama Department of Transportation Standard Specifications for Highway Construction, 2022 Edition.

END PROJECT CR-146 STA. 239+09.27

END WORK CR-146 STA. 245+00.00

## Justin Hardee, P.E.

COUNTY ENGINEER

## INDEX TO SHEETS PROJECT NO. RALCP 41-146-24 LEE COUNTY

- SHEET NO. SHEET NO.
  - 1 1A - 1B1 C - 1 F2 – 2F 2G - 2H 3 - 3B4 4A - 4C5 – 5B 6 7 8 8A - 8E 8 F 8G - 8I 9 – 9A

TITLE SHEET INDEX TO SHEETS & STANDARD DRAWINGS GEOMETRIC DATA SHEET TYPICAL SECTIONS PROJECT NOTES SUMMARY OF QUANTITIES PLAN SHEET PROFILE SHEET PAVING DETAIL SHEET SIGNAGE AND STRIPING DETAIL SHEET UNDERGROUND UTILITIES SHEET TRAFFIC CONTROL PLAN - SEQUENCE OF CONSTRUCTION TRAFFIC CONTROL PLAN - PHASES 1, 2, 3, AND 4 GENERAL TRAFFIC CONTROL PLAN NOTES TEMPORARY TRAFFIC CONTROL PLAN SHEETS DRAINAGE CROSS SECTIONS SHEET NO. 10 - 10G ROADWAY CROSS SECTIONS

REFERENCE Project no.	FISCAL YEAR	SHEET NO.	
RALCP 41-146-24	2025	1 A	

## STANDARD DRAWINGS PROJECT NO. RALCP 41-146-24 LEE COUNTY

INDEX NO.	DRAWING NO.	
45013 45014 45017 45018 45019 53001 53004 53005 62301 62307 62307 62307 65901 66502 66505 66505 66506 66507 66508 66509 66512 66515	CPJ-450 (SHEET 1 OF 2) CPJ-450 (SHEET 2 OF 2) DSA-450 (SHEET 1 OF 3) DSA-450 (SHEET 2 OF 3) DSA-450 (SHEET 3 OF 3) HEP-1 RPC-530 (SHEET 1 OF 3) RPC-530 (SHEET 2 OF 3) 623-N SPEC 623-XY PC (ACG-71) ESC-509 ESC-100-1 ESC-200-1 ESC-200-2 ESC-200-3 ESC-200-4 ESC-300-1 ESC-300-4	DETAILS DETAILS DOWEL SU DOWEL SU DOWEL SU HYDRAULI BEDDING BEDDING BEDDING DETAILS DETAILS DETAILS DETAILS DETAILS DETAILS DETAILS DETAILS
66516 66517 66518 66522 66523 66523 66525 66535 68001 70101 70104 70302 70501 70504 71017 71032	ESC-300-5 ESC-300-7 ESC-300-8 ESC-400-1 ESC-400-2 ESC-400-3 ESC-400-4 ESC-502 ESC-503 GN-2 NOTES PS-701-6 197-NPL TCM-703 (SHEET 1 OF 2) TCM-703 (SHEET 2 OF 2) PM-705-1 PM-705-2 IHS-710-12 IHS-710-21	DETAILS DETAILS DETAILS DETAILS INLET PR INLET PR INLET PR INLET PR STABILIZ TEMPORAT STANDARD DETAILS DETAILS DETAILS DETAILS DETAIL F
71035 71041 71060 71062 71063 71067 71069 71075 71079 71090 71090 71091 71092 71093 71094 71095 74007 74201 74202 74203	IHS-710-23 SL-710 SHS-1 SHS-3 SHS-4 SHS-8 SHS-10 SHS-13 SHS-17 SHS-18 SHS-26 SHS-26 SHS-27 SHS-28 SHS-29 SHS-30 SHS-30 SHS-31 TCD-100 PCMS-710 (SHEET 1 OF 3) PCMS-710 (SHEET 2 OF 3) PCMS-710 (SHEET 3 OF 3)	LIGHTWEI TYPICAL STANDARE

THE FOLLOWING ARE SPECIAL OR STANDARD DRAWINGS CONTAINED IN THE ALABAMA DEPARTMENT OF TRANSPORTATION SPECIAL & STANDARD HIGHWAY DRAWINGS BOOK (U.S. CUSTOMARY UNITS OF MEASUREMENT) DATED 2024 WHICH APPLY TO THIS PROJ

## DESCRIPTION

OF STANDARD PLAIN AND REINFORCED CEMENT CONCRETE PAVEMENT AND BRIDGE END SLABS OF STANDARD PLAIN AND REINFORCED CEMENT CONCRETE PAVEMENT AND BRIDGE END SLAB JOINTS SUPPORT ASSEMBLY FOR CONCRETE PAVEMENT FOR 10" AND 13" THICK SLABS SUPPORT ASSEMBLY FOR CONCRETE PAVEMENT FOR 10" AND 13" THICK SLABS SUPPORT ASSEMBLY FOR CONCRETE PAVEMENT FOR 10" AND 13" THICK SLABS ICALLY EQUIVALENT ROUND PIPES (STORM SEWER) AND FILL HEIGHTS FOR ALL ROADWAY PIPE CULVERTS (RCP AND CMP) AND FILL HEIGHTS FOR ALL ROADWAY PIPE CULVERTS (CMP AND RCP) OF MEDIAN OPENING AND SAFETY GORES AT TRAFFIC CHANNEL ISLANDS OF CONCRETE CURBS AND CONCRETE CURB & GUTTER COMBINATIONS, SLOPING AND VERTICAL TYPE OF CURB & GUTTER MACHINE MOLDS (THIS SHEET FOR USE IN SELECTING MACHINE MADE CONCRET OF ROLLED AND HYDRAULIC EROSION CONTROL PRODUCT INSTALLATION ANAGEMENT PRACTICE REFERENCE MATRIX ANAGEMENT PRACTICE REFERENCE MATRIX TEMPORARY EROSION/SEDIMENT CONTROL APPLICATIONS OF TEMPORARY SLOPE DRAIN, BERMS, AND ENERGY DISSIPATOR OF SEDIMENT BARRIER APPLICATIONS OF SILT FENCE INSTALLATION OF SEDIMENT RETENTION BARRIER HECK STRUCTURE, TYPICAL APPLICATIONS AND DETAILS OF EROSION CONTROL WATTLE DITCH CHECKS OF SILT DIKE DITCH CHECKS OF ROCK DITCH CHECKS OF ROCK DITCH CHECKS WITH SUMP EXCAVATION OF SILT FENCE DITCH CHECKS PROTECTION TYPICAL APPLICATIONS AND DETAILS PROTECTION DETAILS FOR COARSE AGGREGATE ON GRADES & SAGS PROTECTION DETAILS OF WATTLES PROTECTION DETAILS OF SILT FENCE ZED CONSTRUCTION ENTRANCE ARY DEWATERING STRUCTURES RD DESIGN NOTES FOR PLAN ASSEMBLIES OF TRAFFIC STRIPING FOR 2 LANE HIGHWAYS OF NO PASSING LINES FOR TWO LANE. TWO DIRECTION ROADWAY NT LEGENDS AND MARKINGS NT LEGENDS AND MARKINGS OF PAVEMENT MARKERS CLASS A, A-H, AND B SHOWING APPLICATION OF PAVEMENT MARKERS OF ROADWAY SIGN POST (SMALL CHANNEL AND TUBULAR SECTION) FOR LOCATION AND MOUNTING STANDARD FLAT PANEL SIGNS ON U-CHANNEL AND TUBULAR POSTS EIGHT STRUCTURAL SIGN SUPPORT INSTALLATIONS STOP AND YIELD SIGN INSTALLATIONS RD HIGHWAY SIGNS FOR TRAFFIC CHANNELIZATION DEVICES OF PORTABLE CHANGEABLE MESSAGE SIGNS (PCMS) OF PORTABLE CHANGEABLE MESSAGE SIGNS (PCMS) OF PORTABLE CHANGEABLE MESSAGE SIGNS (PCMS)

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TE CURBS OR CONCRETE CUR & GUTTER COMBINATIONS)	

## GEOMETRIC LAYOUT PROJECT NO. RALCP 41-146-24 LEE COUNTY

STA. 233+10.35, 12.0' LT CL LEE ROAD 146 =


STA. 0+00 BL ROUNDABOUT NW

BEGIN PROJECT Sta. 233+10.35 CL Lee Rd. 146

N=5066 E=4657.

POB <u>STA. 233+00</u> N=5080.97 E=4651.52

STA. 233+10.35, 12.0' RT CL LEE ROAD 146 = STA. 0+00 BL ROUNDABOUT SW

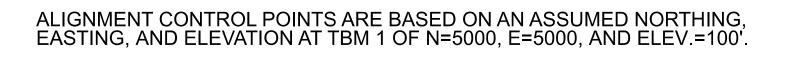

TBM 1 NORTHING = 5000.00 EASTING = 5000.00 ELEV. = 100.00 DESCRIPTION = NAIL SET

TBM 2 NORTHING = 4813.9240 EASTING = 4847.5570 ELEV. = 98.39 DESCRIPTION = NAIL SET

TBM 3 NORTHING = 4930.8590 EASTING = 4893.0960 ELEV. = 100.58 DESCRIPTION = NAIL SET IN POWER POLE

TBM 4 NORTHING = 5344.3160 EASTING = 5014.9890 ELEV. = 105.60 DESCRIPTION = NAIL SET

TBM 5 NORTHING = 4959.4320 EASTING = 4889.1570 ELEV. = 100.07 DESCRIPTION = NAIL SET

TBM 6 NORTHING = 5070.0630 EASTING = 5024.6110 ELEV. = 103.58 DESCRIPTION = NAIL SET IN POWER POLE



FISCAL SHEET YEAR NO.

REFERENCE PROJECT NO.

## **ROUNDABOUT SOUTHEAST BASELINE**

Element Circo	ılar C1	STATION	NORTHING	EASTING
	РОВ	0+00.	4694.26	4892.06
	PI	0+18.85		
	PRC	0+37.69	4729.87	4904.36
	Radius	572.961		
	Length	37.6864		
	Degree of Curvature (D)	9.9999		
	Delta (Sweep Angle)(Degrees)	3.7686		
	Delta (Radians)	0.0658		
	Tangent	18.8500		
	Chord	37.6796		
	Middle Ordinate	0.3098		
Element Circu	ılar C2	STATION	NORTHING	EASTING
	PRC	0+37.68	4729.87	4904.36
	PI	0+98.86		
	PRC	1+59.58	4847.36	4936.01
	Radius Length	575 121.9		
	Length	121.9 9.9645		
	Degree of Curvature (D) Delta (Sween Angle)(Degrees)	9.9645 12.1467		
	Delta (Sweep Angle)(Degrees) Delta (Radians)	0.2120		
	Tangent Chord	61.1793 121.6719		
	Middle Ordinate	3.2273		
Element Circu			NORTHING	EASTING
	PRC	1+59.58	4847.36	4936.01
	PI	1+82.57		
	PCC	2+05.19	4890.58	4950.00
	Radius	147.8162		
	Length	45.6125		
	Degree of Curvature (D)	38.7615		
	Delta (Sweep Angle)(Degrees)	17.6801		
	Delta (Radians)	0.3086		
	Tangent	22.9890		
	Chord	45.4317		
	Middle Ordinate	1.7559		
Element Circu	llar CA	STATION	NORTHING	EASTING
	PCC	2+05.2	4890.58	4950.00
	PI	2+03.2 2+41.27	JU.JU	T700.00
	PCC	2+41.27 2+71.81	4925.06	5004.06
		2 - / 1.01	7743,00	2007.00
	Radius	70		
	Length	66.6064		
	Degree of Curvature (D)	81.8511		
	Delta (Sweep Angle)(Degrees)	54.5181		
	Delta (Radians)	0.9515		
	Tangent	36.0663		
	Chord	64.1220		
	Middle Ordinate	7.7739		
Element Circo	ılar C5	STATION	NORTHING	EASTING
	PCC	2+71.81	4925.06	5004.06
	PI	3+01.85		
	РТ	3+31.6	4923.42	5063.69
	Radius	250		
		250 59.789		
	Length			
	Degree of Curvature (D) Delta (Sween Angle)(Degrees)	22.9183 13.7026		
	Delta (Sweep Angle)(Degrees) Delta (Radians)	0.2392		
		0.2 <i>3</i> 92 30.0378		
	Tangent Chord	30.0378 59.6466		
	Middle Ordinate	1.7852		
		1./032		

## GEOMETRIC LAYOUT PROJECT NO. RALCP 41-146-24 LEE COUNTY

Element:	Linear		STATION	NORTHING	EASTING	
		PT	3+31.59	4923.42	5063.69	
		PI	4+18.54	4899.13	5147.17	
		Bearing	S73°47'19''E			
		Length	86.95			
Element:	Linear		STATION	NORTHING	EASTING	
		PI	4+18.54	4899.13	5147.17	
		POE	4+99.81	4872.74	5224.04	
		Bearing	S71°03'17"E			
		Length	81.27			
		-		~~~~~		
	ŀ	ROUNDABOUT SOUTH	WEST BAS	SELINE		
Element	Circular			NORTHING		
		POB	0+00.	5066.09	4657.09	
		PI	0+52.18			
		PRC	1+04.23	5027.71	4753.93	
		Radius	879.784			
		Length	104.2306			
		Degree of Curvature (D)	6.5125			
		Delta (Sweep Angle)(Degrees)	6.7880			
		Delta (Radians)	0.1185			
		Tangent	52.1763			
		Chord	104.1697			
		Middle Ordinate	1.5431			
Element	Circular		STATION	NORTHING	EASTING	
		PRC	1+04.23	5027.71	4753.93	
		PI	1+54.32			
		РТ	2+04.29	4990.25	4846.65	
		Radius	844.5683			
		Length	100.0585			
		Degree of Curvature (D)	6.7840			
		Delta (Sweep Angle)(Degrees)	6.7880			
		Delta (Radians)	0.1185			
		Tangent	50.0878			
		Chord	100.0000			
		Middle Ordinate	1.4813			
Element:	Linear			NORTHING		
		PT	2+04.3	4990.25	4846.65	
		PC	2+19.71	4985.23	4861.24	
		Bearing	S71°00'08''E			
		Length	15.41			
Element	Circular			NORTHING		
		PC	2+19.71	4985.23	4861.24	
		PI	2+61.98	4000.05	4004.04	
		PCC	2+94.67	4929.35	4904.84	
		Radius	65 74.0(17			
		Length	74.9617			
		Degree of Curvature (D)	88.1474			
		Delta (Sweep Angle)(Degrees)	66.0768			
		Delta (Radians)	1.1533			
		Tangent	42.2734			
		Tangent Chord Middle Ordinate	42.2734 70.8761 10.5101			

Element

Element

Element

REFERENCE	FISCAL	SHEET .
Project no.	YEAR	NO.
RALCP 41-146-24	2025	1 D

t Circular	С9	<b>STATION</b>	NORTHING	EASTING
	PCC	2+94.68	4929.35	4904.84
	PI	3+22.44		
	PCC	3+50.13	4873.95	4906.19
	Radius	450		
	Length	55.4519		
	Degree of Curvature (D)	12.7324		
	Delta (Sweep Angle)(Degrees)	7.0604		
	Delta (Radians)	0.1232		
	Tangent	27.7611		
	Chord	55.4168		
	Middle Ordinate	0.8539		
t Circular	C10	STATION	NORTHING	EASTING
	PCC	3+50.13	4873.95	4906.19
	PI	4+00.85		
	PCC	4+51.18	4774.24	4890.99
	Radius	469.3		
	Length	101.0533		
	Degree of Curvature (D)	12.2088		
	Delta (Sweep Angle)(Degrees)	12.3374		
	Delta (Radians)	0.2153		
	Tangent	50.7228		
	Chord	100.8582		
	Middle Ordinate	2.7173		
t Circular	C11	STATION	NORTHING	EASTING
	PCC	4+51.18	4774.24	4890.99
	PI	4+89.58		
	POE	5+27.97	4700.36	4870.08
	Radius	1477.4438		
	Length	76.7926		
	Degree of Curvature (D)	3.8780		
	Delta (Sweep Angle)(Degrees)	2.9780		
	Delta (Radians)	0.0520		
	Tangent	38.4049		
	Chord	76.7840		
	Middle Ordinate	0.4989		

### **ROUNDABOUT NORTHWEST BASELINE**

Element: Linear	POB PI Bearing Length	<b>STATION</b> 0+00. 1+33.33 S71°03'14"E 133.33	NORTHING 5088.78 5045.49	<b>EASTING</b> 4665.42 4791.53
Element: Linear		STATION	NORTHING	EASTING
	PI	1+33.33	5045.49	4791.53
	PC	2+01.21	5023.88	4855.87
	Bearing Length	S71°25'58"E 67.88		
Element Circular	C12	STATION	NORTHING	EASTING
	PC	2+01.21	5023.88	4855.87
	PI	2+46.58		
	PCC	2+85.25	5038.01	4935.65
	Radius	90.0000		
	Length	84.043		
	Degree of Curvature (D)	63.6620		
	Delta (Sweep Angle)(Degrees)	53.5035		
	Delta (Radians)	0.9338		
	Tangent	45.3671		
	Chord	81.0225		
	Middle Ordinate	9.6331		
Element Circular			NORTHING	EASTING
	PCC	2+85.25	5038.01	4935.65
	PI	3+18.73	5001 27	4070 20
	PCC	3+49.94	5091.37	4970.28
	Radius	101.9770		
	Length	64.6917		
	Degree of Curvature (D)	56.1850		
	Delta (Sweep Angle)(Degrees)	36.3471		
	Delta (Radians)	0.6344		
	Tangent	33.4761		
	Chord Middle Ordinate	63.6124 5.0870		
Element Cincular	C14	STATION	NORTHING	FASTINC
Element Circular	PCC	<b>STATION</b> 3+49.94		EASTING
	PI	3+49.94 3+90.42	5091.37	4970.28
	PCC	3+90.42 4+30.12	5169.48	4985.62
	Radius	235.4085		
	Length	80.1803		
	Degree of Curvature (D)	24.3389		
	Delta (Sweep Angle)(Degrees)	19.5150		
	Delta (Radians)	0.3406		
	Tangent	40.4823		
	Chord	79.7933		
	Middle Ordinate	3.4054		
Element Circular		STATION	NORTHING	EASTING
	PCC	4+30.12	5169.48	4985.62
	PI PRC	4+49.14 4+68.08	5207.39	4981.72
	Radius	231.2078		
	Length	37.958		
		24.7811		
	Degree of Curvature (D)			
	Delta (Sweep Angle)(Degrees)	9.4064		
	Delta (Sweep Angle)(Degrees) Delta (Radians)	9.4064 0.1642		
	Delta (Sweep Angle)(Degrees) Delta (Radians) Tangent	9.4064 0.1642 19.0217		
	Delta (Sweep Angle)(Degrees) Delta (Radians)	9.4064 0.1642		

## GEOMETRIC LAYOUT PROJECT NO. RALCP 41-146-24 LEE COUNTY

ement Circular	C16	STATION	NORTHING	EASTING	Element Circular	C21	STATION	NORTHING	
	PCC PI	4+68.08 5+37.32	5207.39	4981.72		PCC PI	3+86.45 4+02.21	4968.83	
	PRC	6+05.77	5344.53	4974.87		PRC	4+17.66	4956.74	
	Radius	529.6700				Radius	90.0000		
	Length	137.6934				Length	31.2158		
	Degree of Curvature (D)	10.8173				Degree of Curvature (D)	63.6620		
	Delta (Sweep Angle)(Degrees)	14.8947				Delta (Sweep Angle)(Degrees)	19.8726		
	Delta (Radians)	0.2600				Delta (Radians)	0.3468		
	Tangent	69.2371				Tangent	15.7663		
	Chord	137.3060				Chord	31.0596		
	Middle Ordinate	4.4681				Middle Ordinate	1.3500		
I	ROUNDABOUT NORTH	EAST BA	SELINE		Element Circular			NORTHING	
	<b>64</b>		NODTHING			PRC PI	4+17.66 4+69.5	4956.74	
lement Circular			NORTHING			PRC	5+20.82	4922.53	
	POB	0+00.	5342.20	4996.81					
	PI	0+66.03				Radius	425.0000		
	PRC	1+31.31	5211.42	5003.34		Length	103.1561		
						Degree of Curvature (D)	13.4814		
	Radius	505.2147					13.4814		
	Length	131.314				Delta (Sweep Angle)(Degrees)			
	Degree of Curvature (D)	11.3409				Delta (Radians)	0.2427		
	Delta (Sweep Angle)(Degrees)	14.8922				Tangent	51.8328		
	Delta (Radians)	0.2599				Chord Middle Ordinate	102.9031		
	Tangent	66.0291				Middle Ordinate	3.1259		
	Chord	130.9447				C22		MODTHE	F
	Middle Ordinate	4.2603			Element Circular			NORTHING	
						PRC	5+20.82	4922.53	-
lement Circular	C18	STATION	NORTHING	EASTING		PI	5+54.53		
	PRC	1+31.31	5211.42	5003.34		POE	5+88.16	4896.11	5
	PI	1+51.51 1+67.89	~ <u>~</u> 1 1, T <u>~</u>						
	PRC	2+03.96	5139.08	5006.36		Radius	536.0669		
		2:03.70	2127.00	2000.20		Length	67.3412		
	Radius	253.2078				Degree of Curvature (D)	10.6882		
						Delta (Sweep Angle)(Degrees)	7.1976		
	Length	72.6504				Delta (Radians)	0.1256		
	Degree of Curvature (D)	22.6280				Tangent	33.7149		
	Delta (Sweep Angle)(Degrees)	16.4393				Chord	67.2969		
	Delta (Radians)	0.2869				Middle Ordinate	1.0571		
	Tangent	36.5765							
	Chord	72.4015				CL LEE ROA	D 146		
	Middle Ordinate	2.6011							
lement Circular	C19	STATION	NORTHING	EASTING	Element: Linear		STATION	NORTHING	EA
	PRC	2+03.96	5139.08	5006.36		POB	233+00.	5080.97	4
	PI	2+64.94				PI	236+00.	4983.12	4
	PCC	3+25.18	5018.35	5011.72		Bearing	S70°57'46''E		
						Length	300.00		
	Radius Length	450.0000 121.2175			Element: Linear		STATION	NORTHING	EA
	Degree of Curvature (D)	121.2173				PI	236+00.	4983.12	4
	Delta (Sweep Angle)(Degrees)	12.7324				PI	230+00. 237+00.	4950.99	4
						Bearing	S71°15'33"E		-
	Delta (Radians)	0.2694				Length	100.00		
	Tangent	60.9779				Lengui	100.00		
	Chord	120.8513					<b>STATION</b>	MODTHING	TE 4
	Middle Ordinate	4.0754			Element: Linear	PI	237+00.	<b>NORTHING</b> 4950.99	EA 5
lamont Circul	C20	ST & TIAN	NODTHING	FASTINC		PI	237+00. 238+00.	4930.99 4919.33	5
lement Circular			NORTHING						2
	PCC	3+25.18	5018.35	5011.72		Bearing	S71°32'42"E		
	PI	3+57.64		50.4.4.00		Length	100.00		
	PCC	3+86.45	4968.83	5044.83	Element: Linear		STATION	NORTHING	EA
	Radius	75.0000				PI	238+00.	4919.33	5
	Length	61.2647				POE	239+09.27	4884.39	-
		76.3944				Bearing	S71°21'08''E		
	Degree of Curvature (D)					Length	109.27		
	Delta (Sweep Angle)(Degrees)	46.8028				Lengui	109.27		
	Delta (Radians)	0.8169							
	Tangent	32.4576							
	-								
	Chord Middle Ordinate	59.5755 6.1691							

REFERENCE	FISCAL	SHEET
Project no.	YEAR	NO.
RALCP 41-146-24	2025	1 E

## CL LEE ROAD 54


Element: Linear	POB PI Bearing Length	<b>STATION</b> 295+00.87 295+47.3 N18°06'47''E 46.43	<b>NORTHING</b> 4653.23 4697.36	<b>EASTING</b> 4866.47 4880.9
Element: Linear	PI PI Bearing Length	<b>STATION</b> 295+47.3 296+00. N16°08'45''E 52.70	NORTHING 4697.36 4747.98	<b>EASTING</b> 4880.9 4895.55
Element: Linear	PI PC Bearing Length	<b>STATION</b> 296+00. 296+50. N14°27'32''E 50.00	NORTHING 4747.98 4796.39	<b>EASTING</b> 4895.55 4908.04
Element Circular	C24 PC PCC POE	<b>STATION</b> 296+50. 297+25. 298+00.	<b>NORTHING</b> 4796.39 4942.58	<b>EASTING</b> 4908.04 4941.66
	Radius Length Degree of Curvature (D) Delta (Sweep Angle)(Degrees) Delta (Radians) Tangent Chord Middle Ordinate	11831.4825 149.997 0.4843 0.7264 0.0127 74.9995 149.9960 0.2377		
Element Circular	C25 PCC PCC POE	<b>STATION</b> 298+00. 298+50. 299+00.	<b>NORTHING</b> 4942.58 5041.21	<b>EASTING</b> 4941.66 4958.02
	Radius Length Degree of Curvature (D) Delta (Sweep Angle)(Degrees) Delta (Radians) Tangent Chord Middle Ordinate	3375.5716 100 1.6974 1.6974 0.0296 50.0037 99.9963 0.3703		
Element Circular	<b>C26</b> PCC PT POE	<b>STATION</b> 299+00. 299+50. 300+00.	<b>NORTHING</b> 5041.21 5140.61	<b>EASTING</b> 4958.02 4968.86
	Radius Length Degree of Curvature (D) Delta (Sweep Angle)(Degrees) Delta (Radians) Tangent Chord Middle Ordinate	2441.5619 100 2.3467 2.3467 0.0410 50.0070 99.9930 0.5119		
Element: Linear	PT PI Bearing Length	<b>STATION</b> 300+00. 301+00. N5°12'18"E 100.00	NORTHING 5140.61 5240.2	<b>EASTING</b> 4968.86 4977.94

## GEOMETRIC LAYOUT PROJECT NO. RALCP 41-146-24 LEE COUNTY

Element: Linear		STATION	NORTHING	EASTING	
	PI	300+00.	5140.61	4968.86	
	POE	302+03.46	5343.35	4985.98	
	Bearing	N4°27'36''E			
	Length	203.46			
CENTRAL ISLAND					


Element Circular CENTRAL ISLAND STATION NORTHING EASTING CENTER 236+23.98 4978.54 4958.88 RADIUS 40 AREA (SQ. FT.) 5026.55 PERIMETER (FT.) 251.3274

		REFERENCE PROJECT NO.		SHEET NO.
	RALCP	41-146-24	2025	1 F

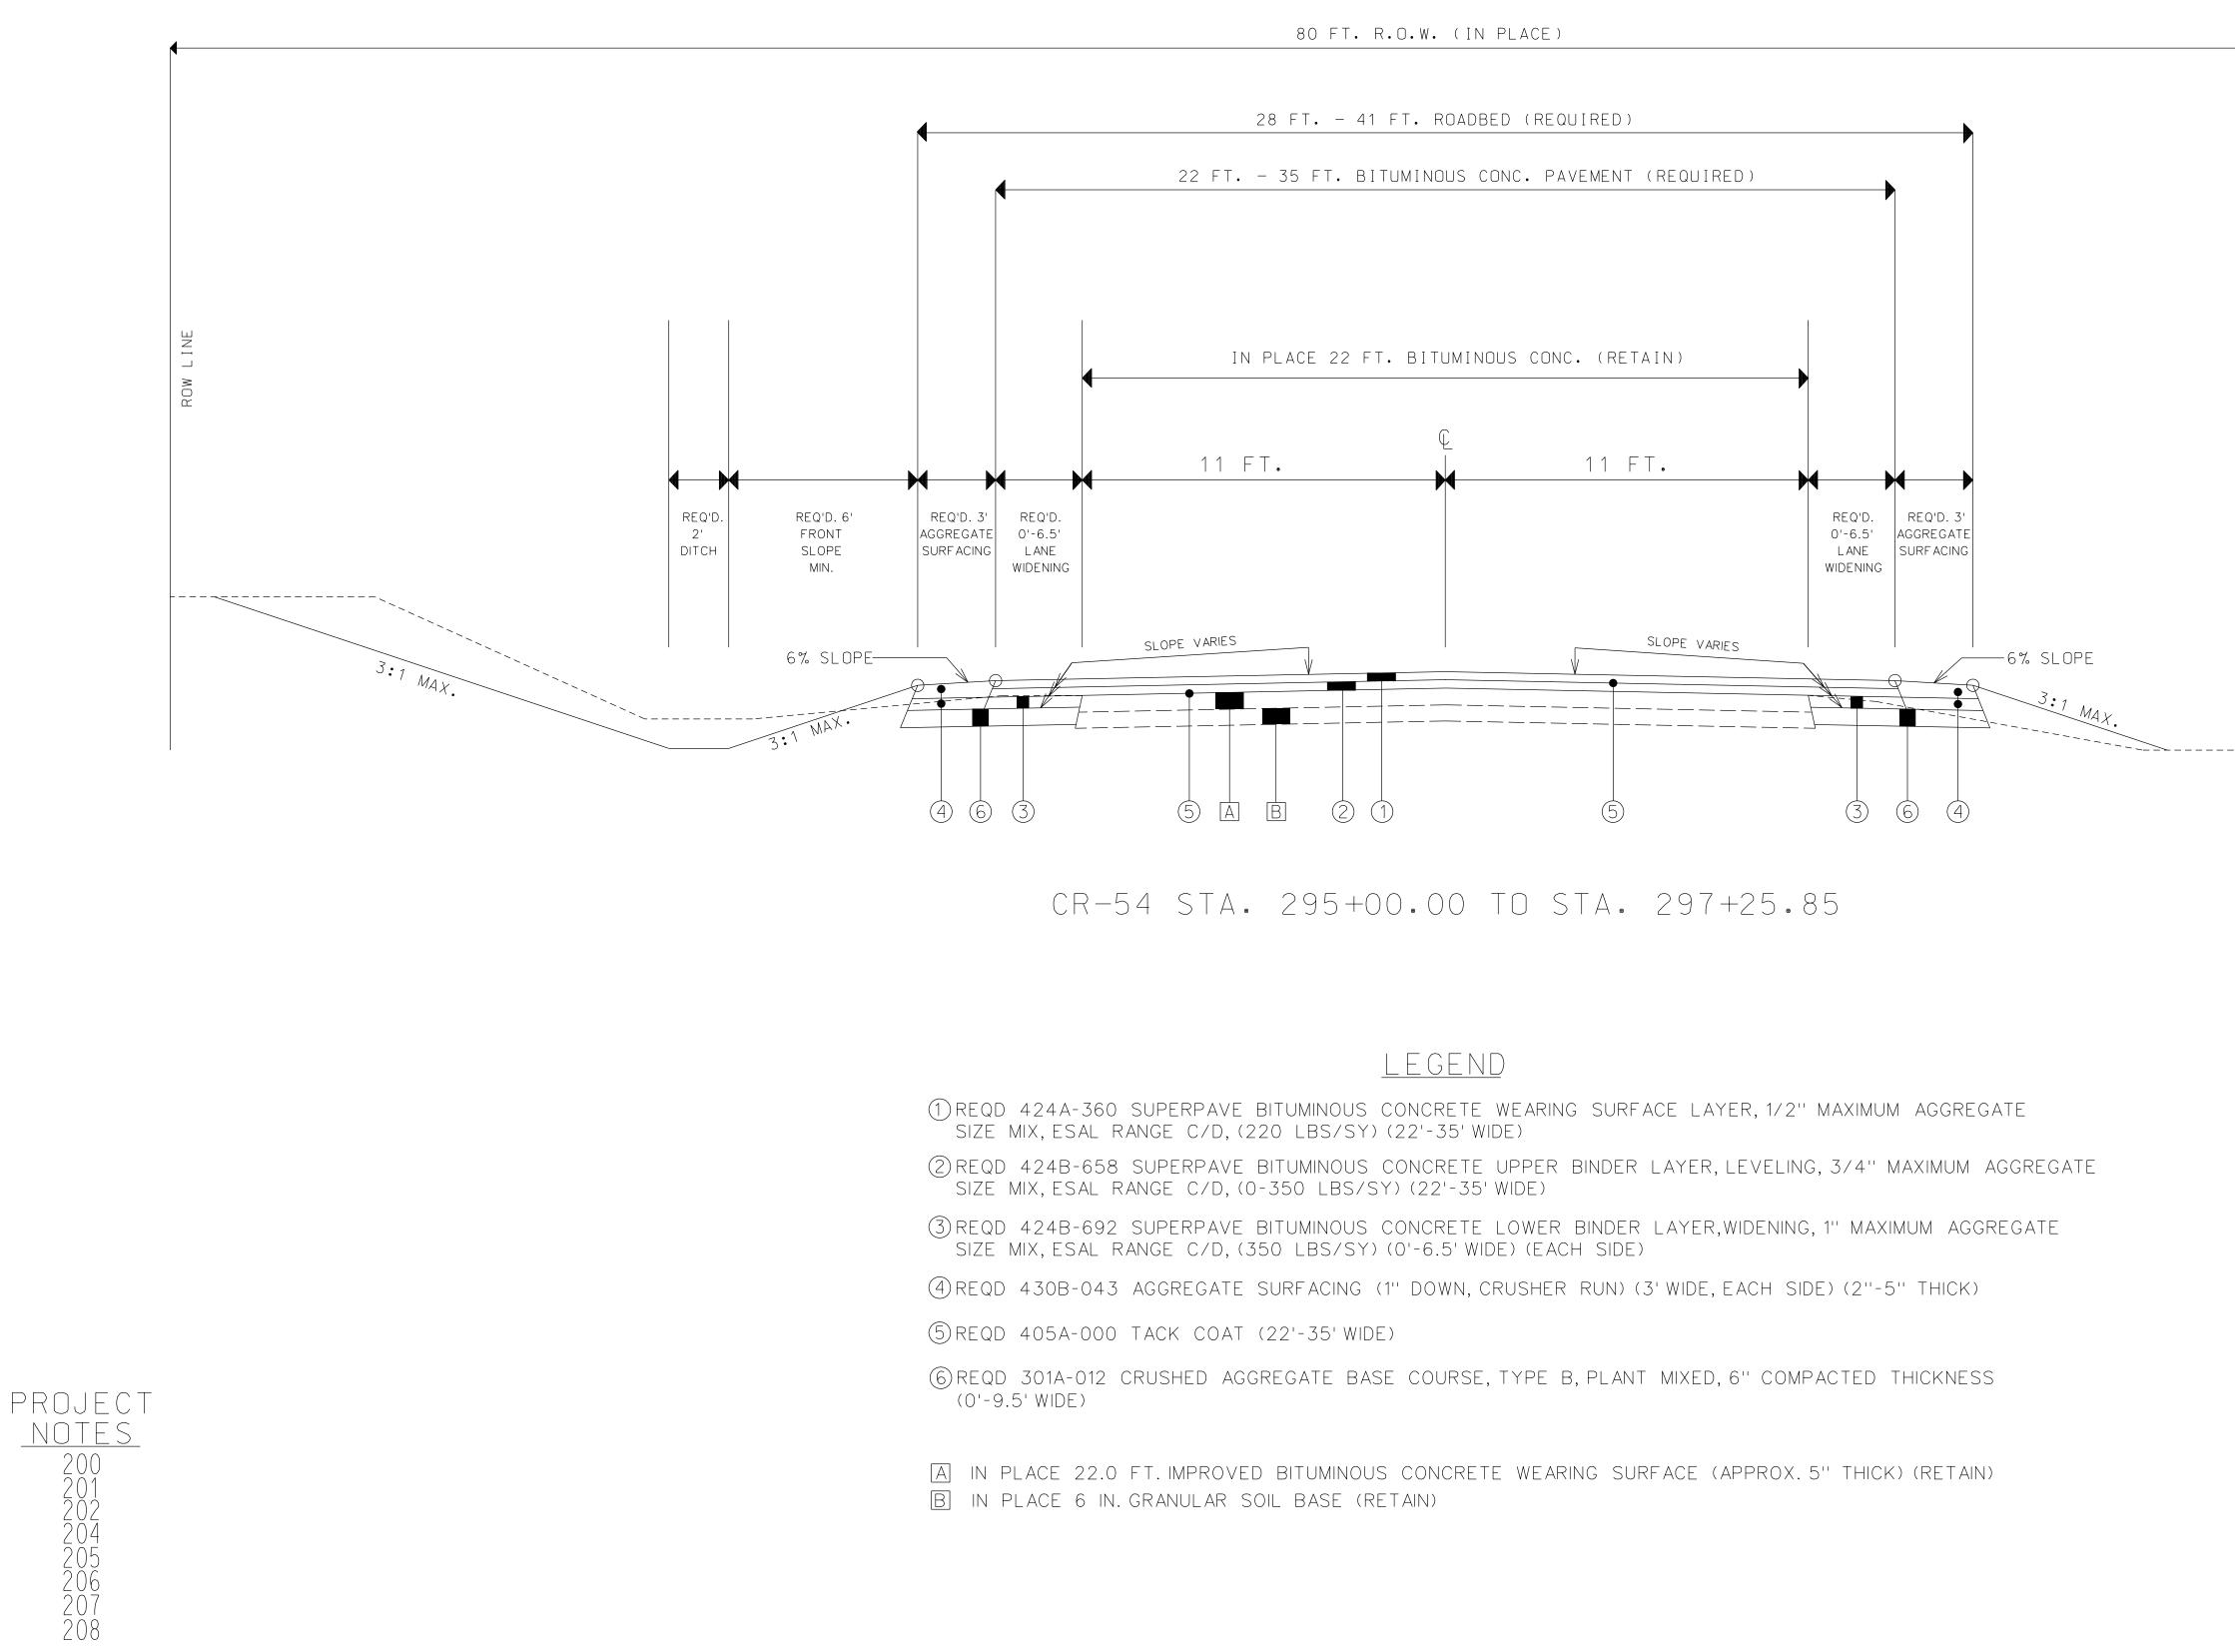


## TYPICAL SECTION PROJECT NO. RALCP 41-146-24 LEE COUNTY


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ROW LI1		
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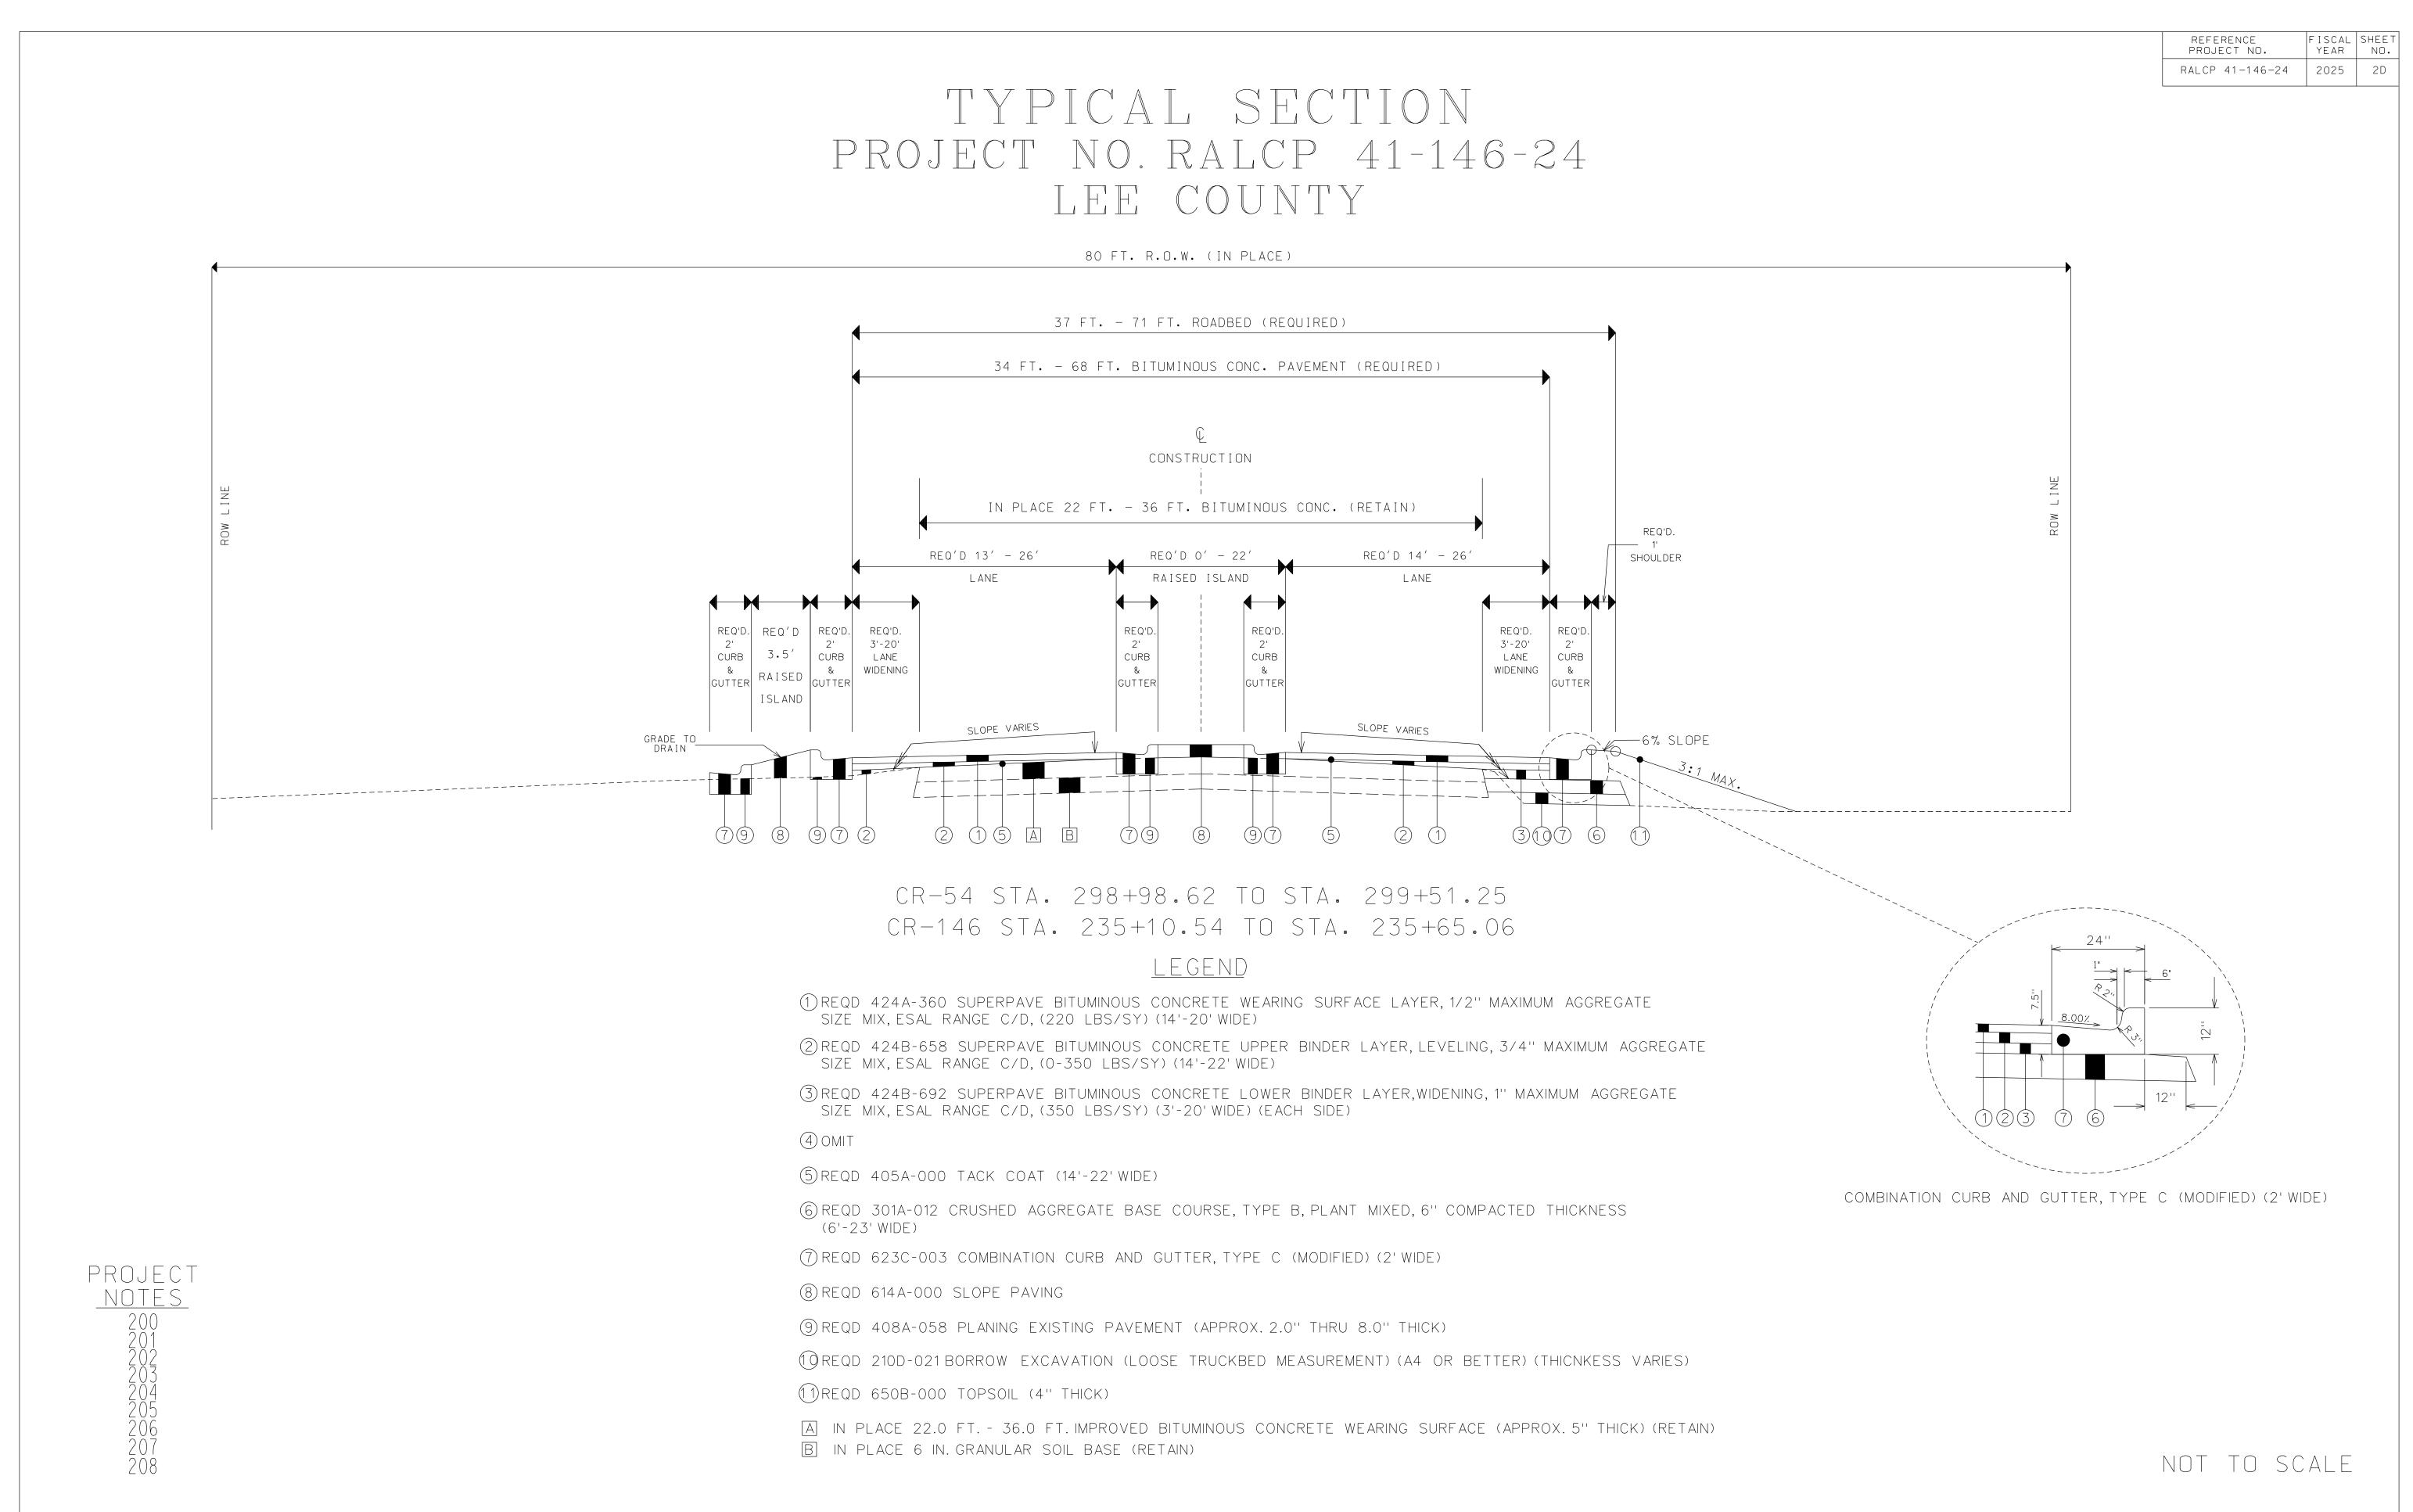


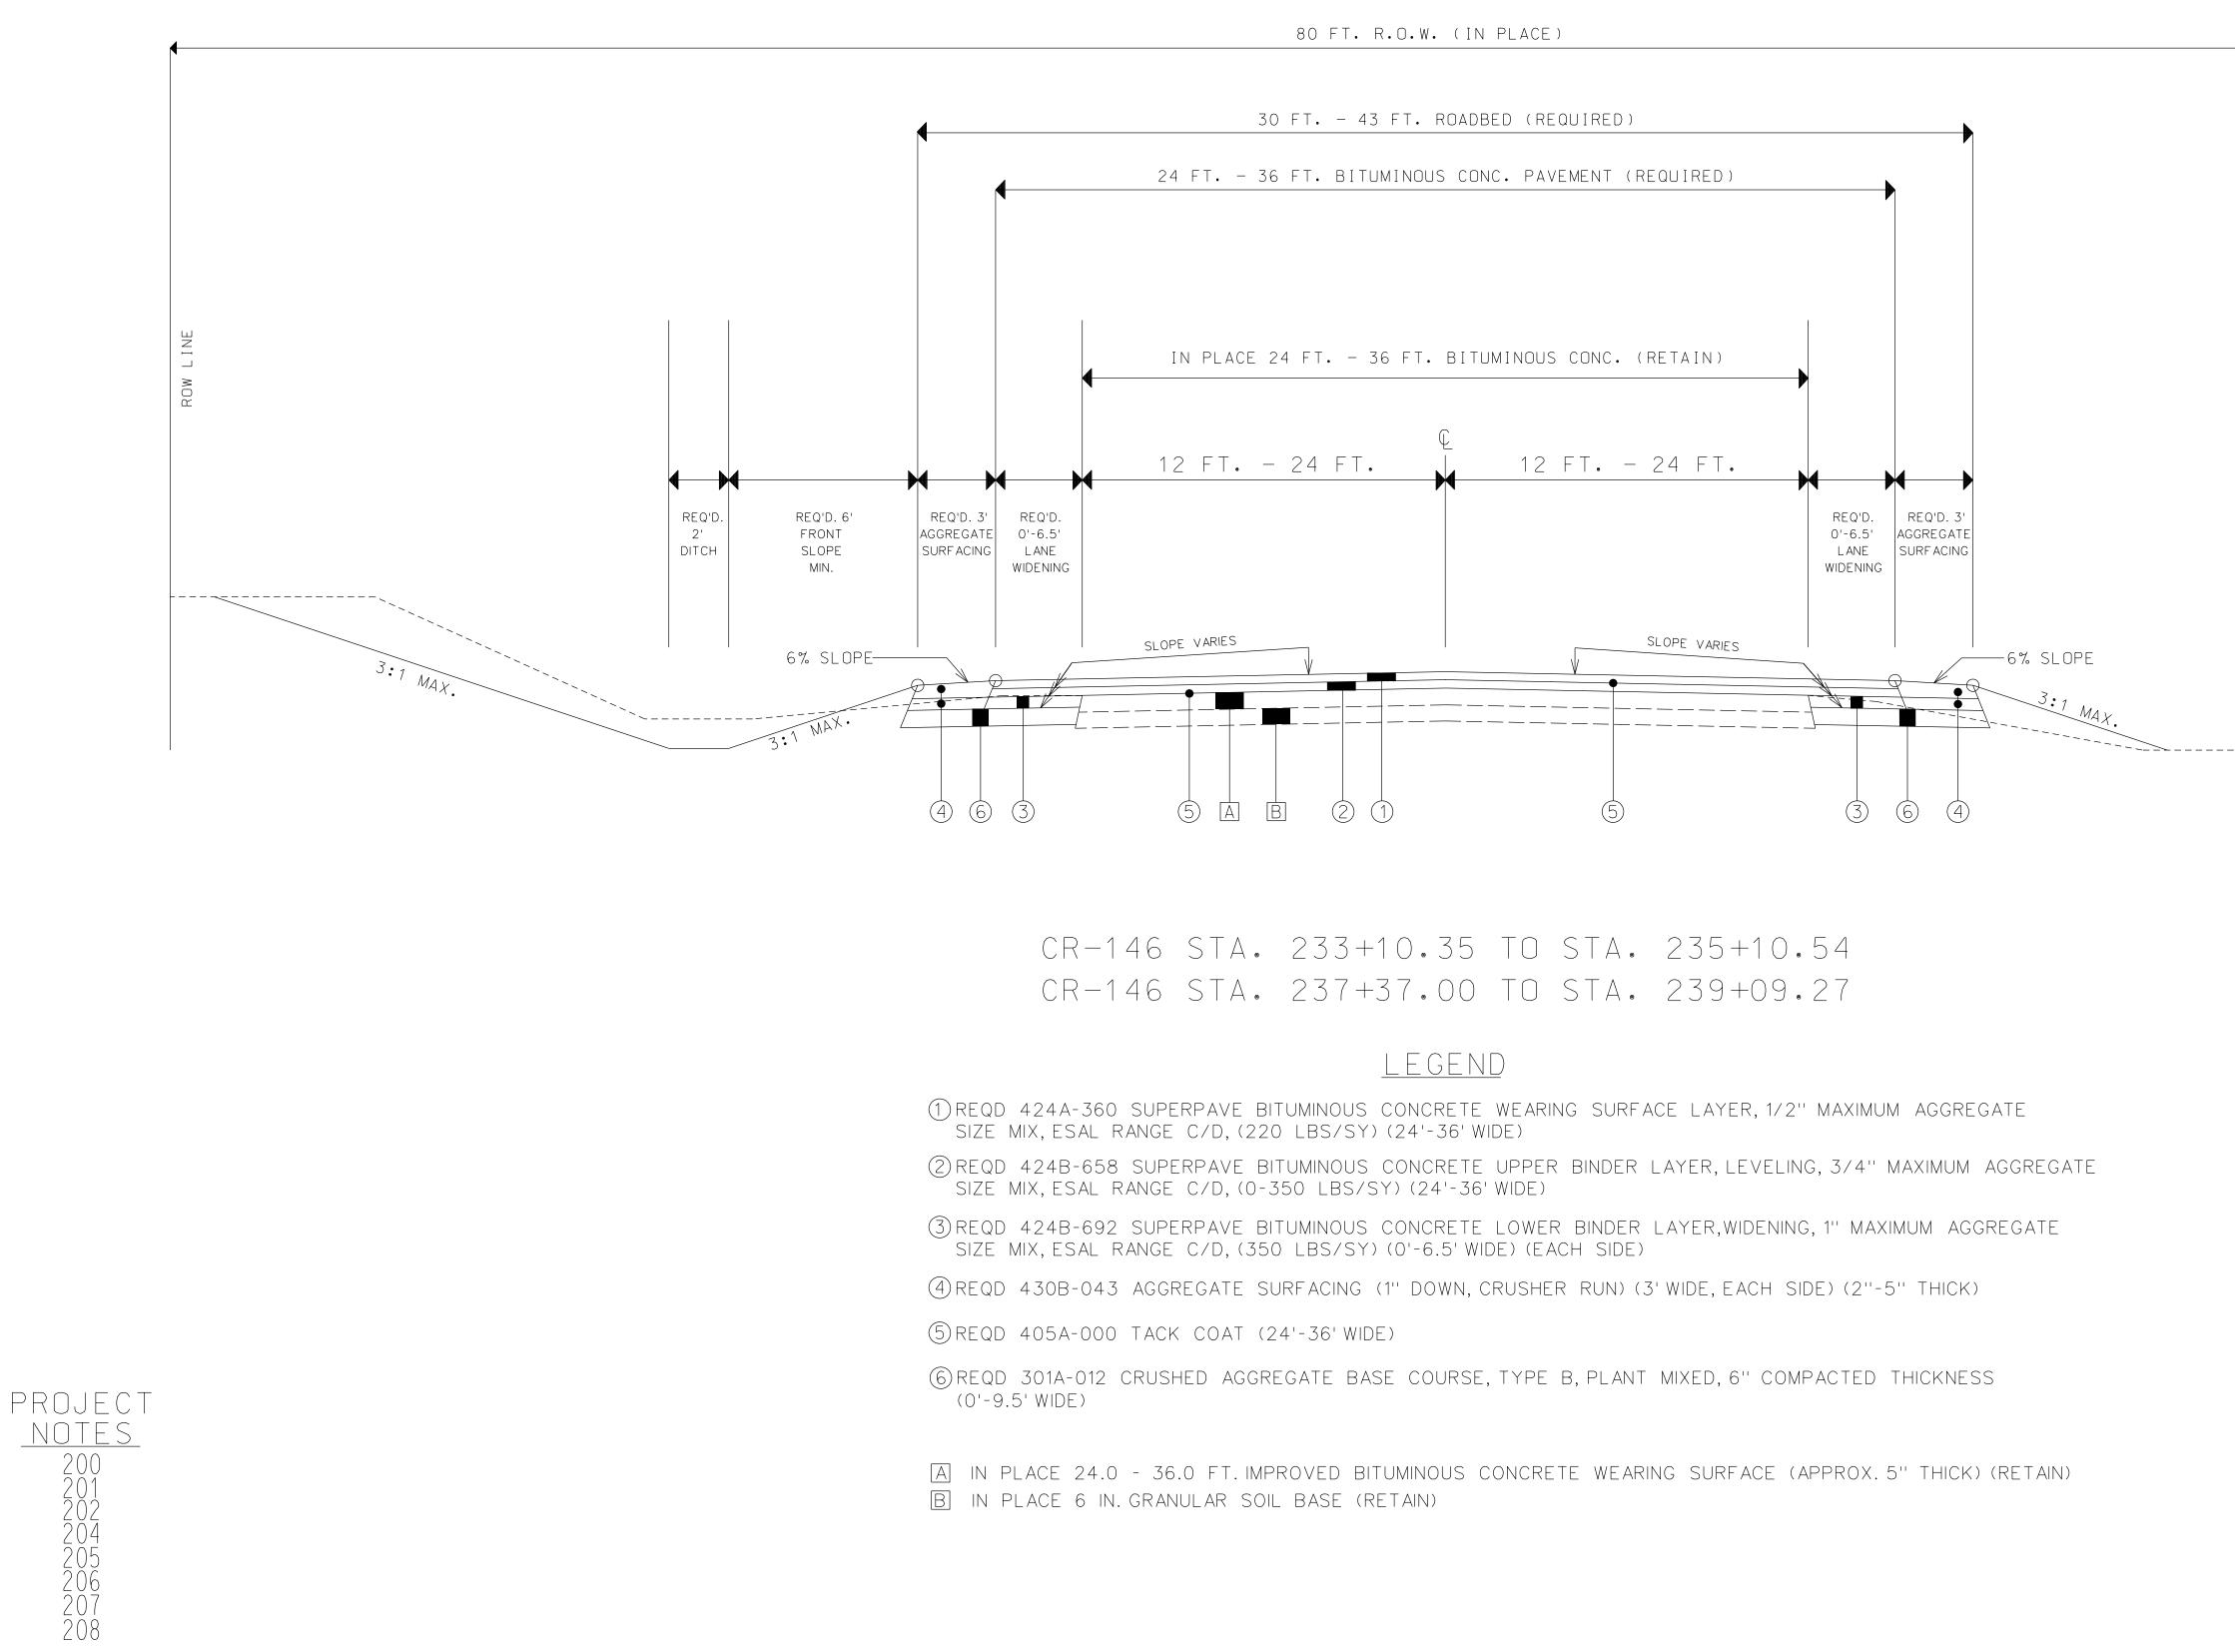
## TYPICAL SECTION PROJECT NO. RALCP 41-146-24 LEE COUNTY

	REFERENCE PROJECT NO. RALCP 41-146-24	FISCAL YEARSHEET NO.20252A
ROW LI		
	NOT TO SC	CALE



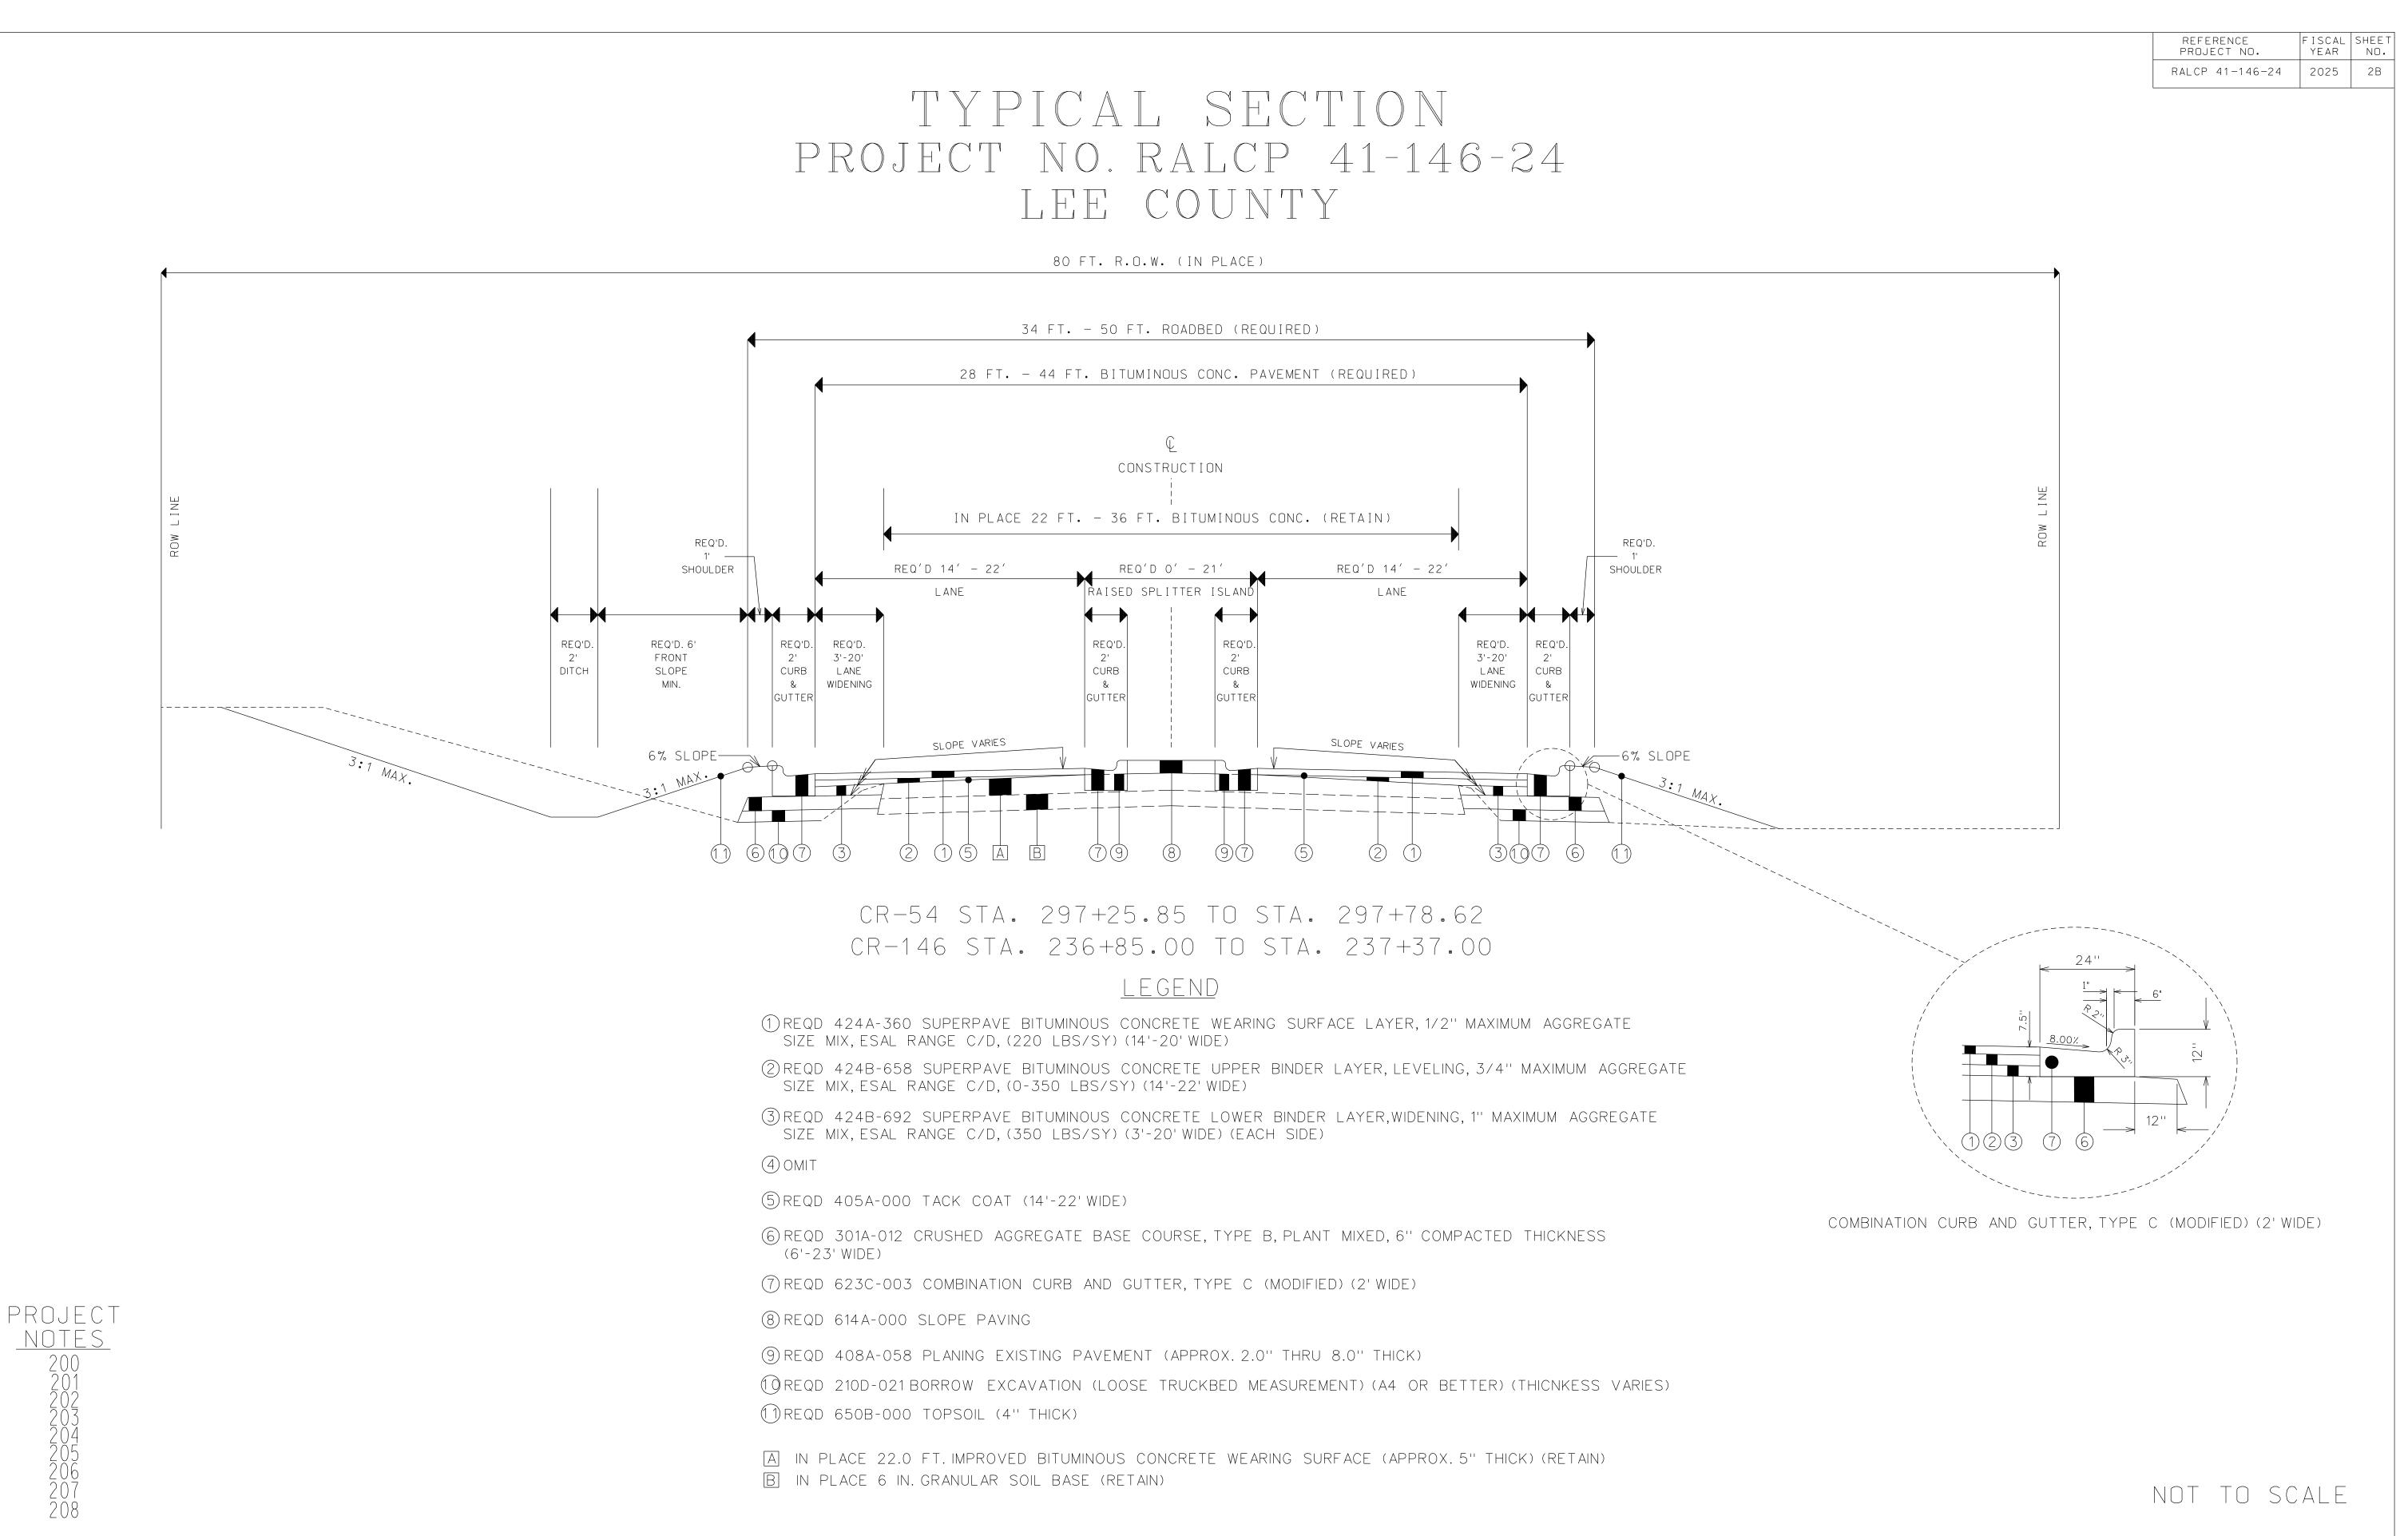


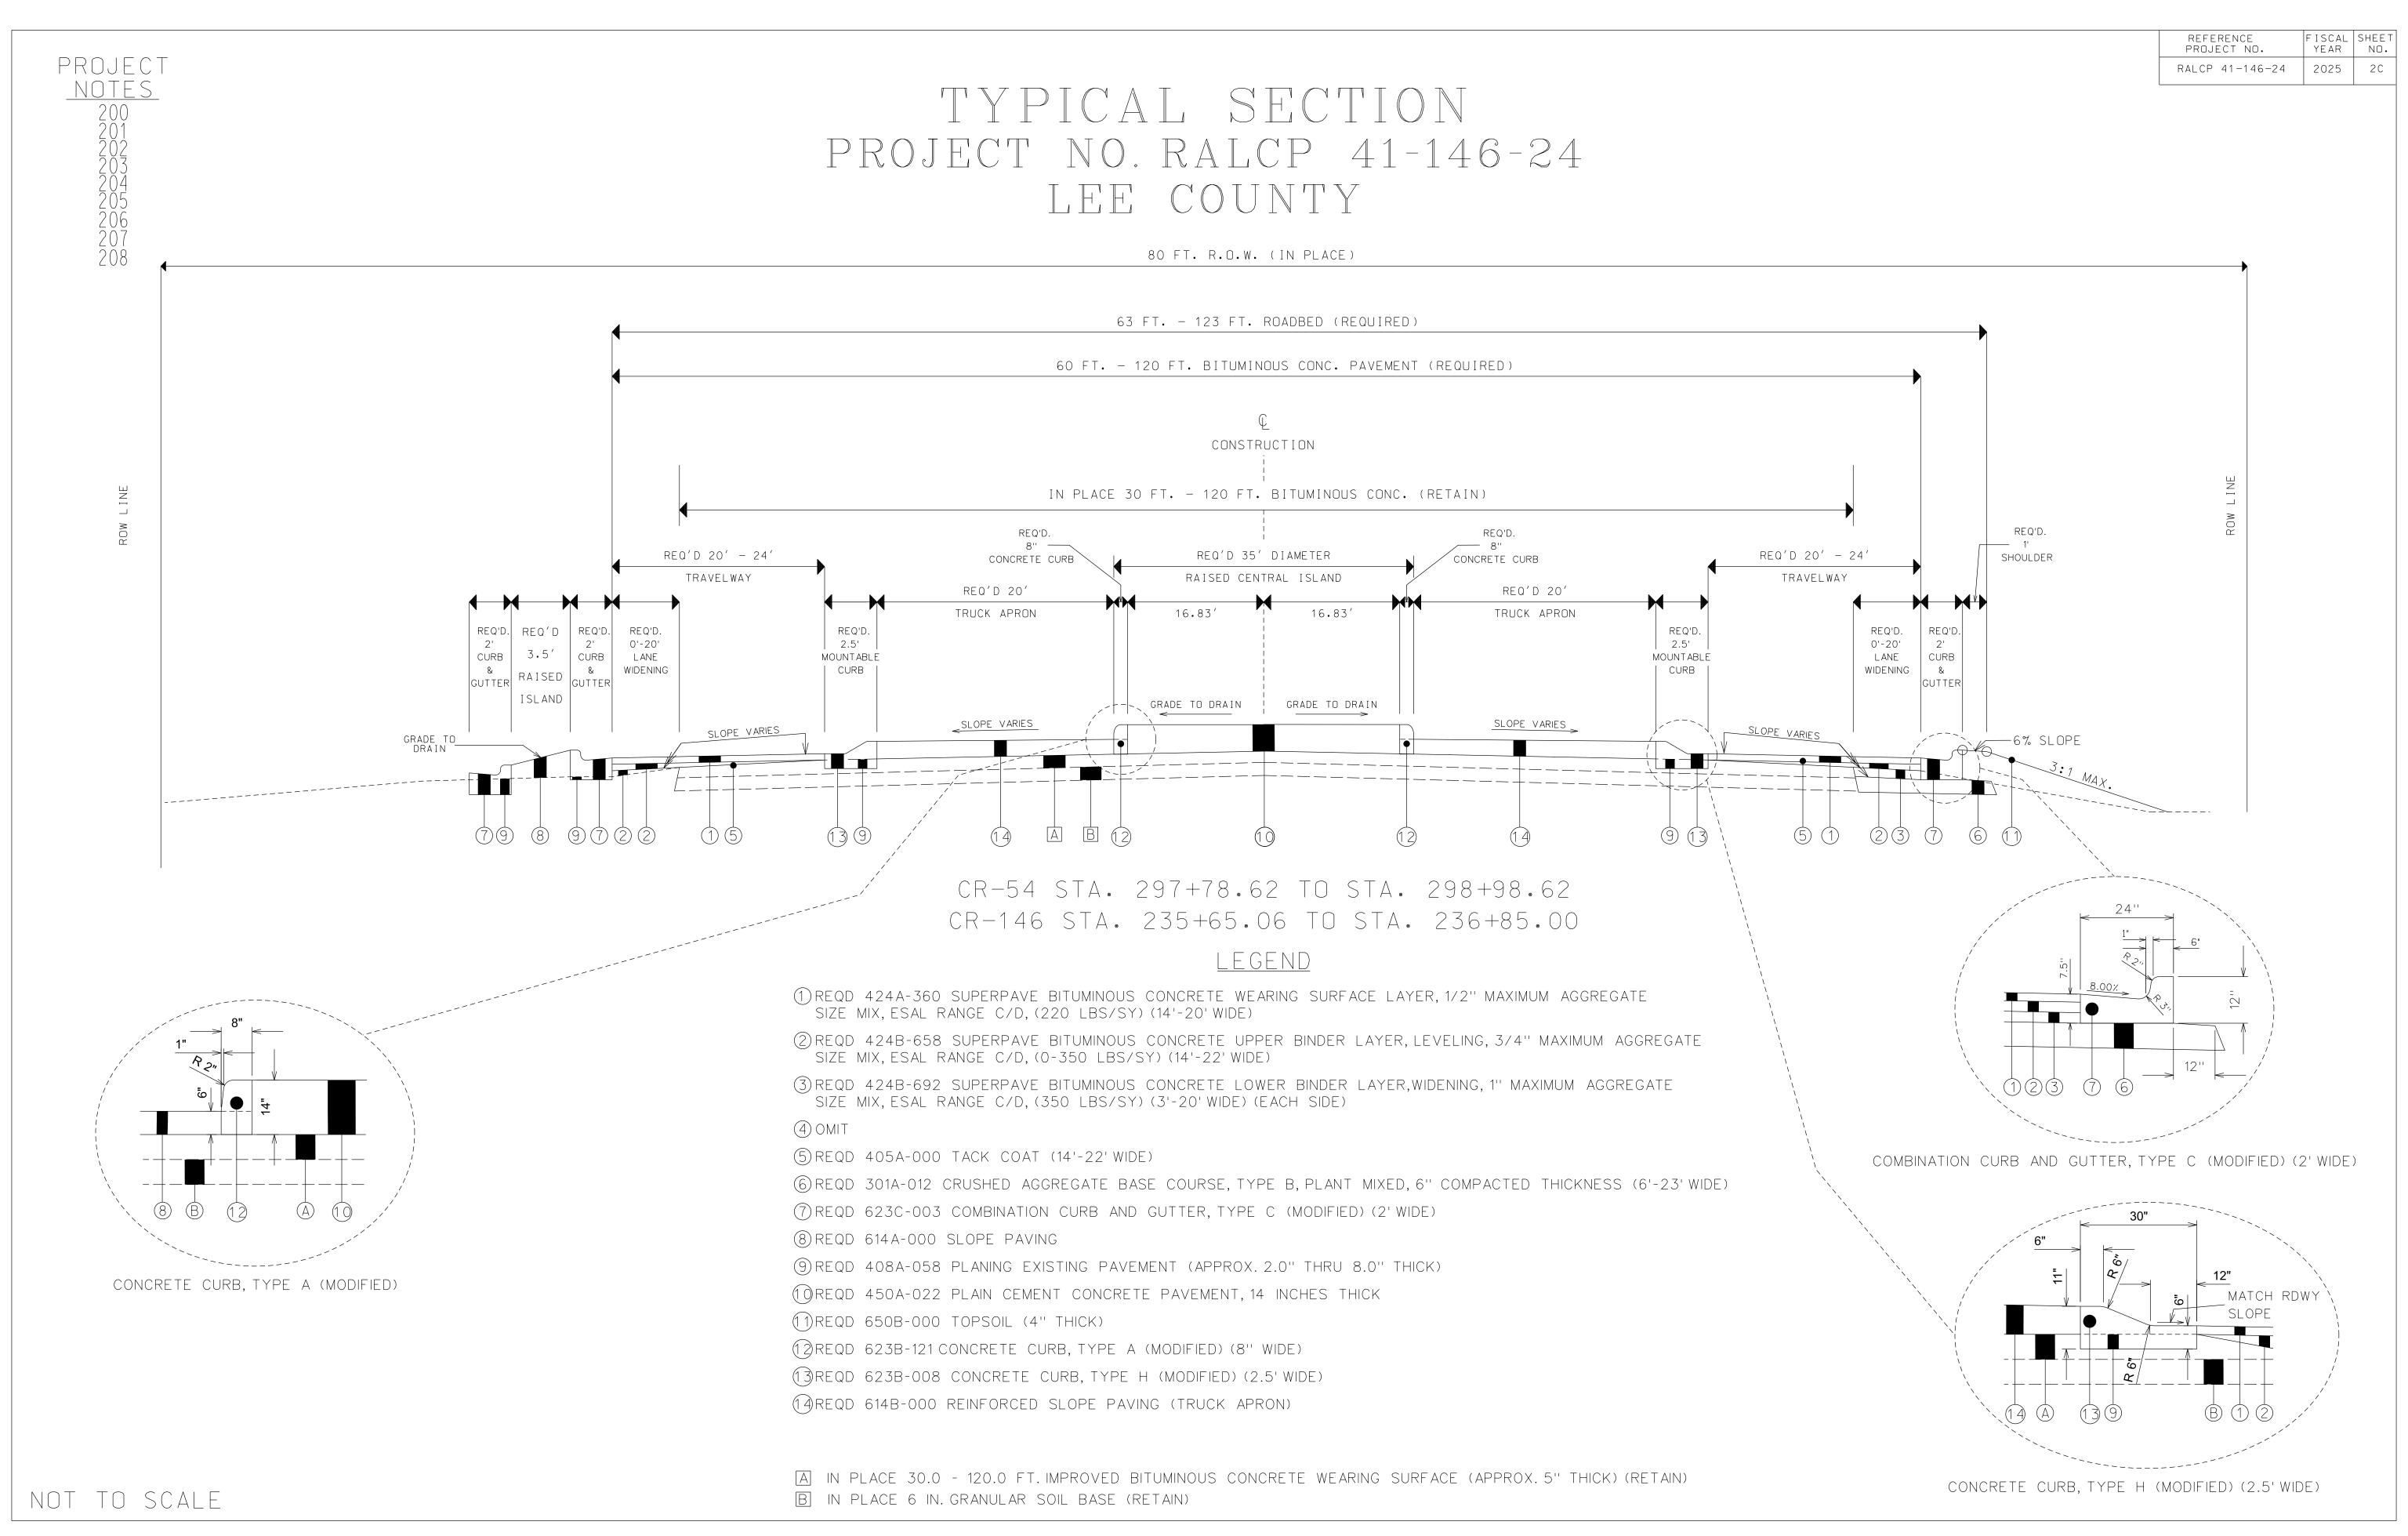

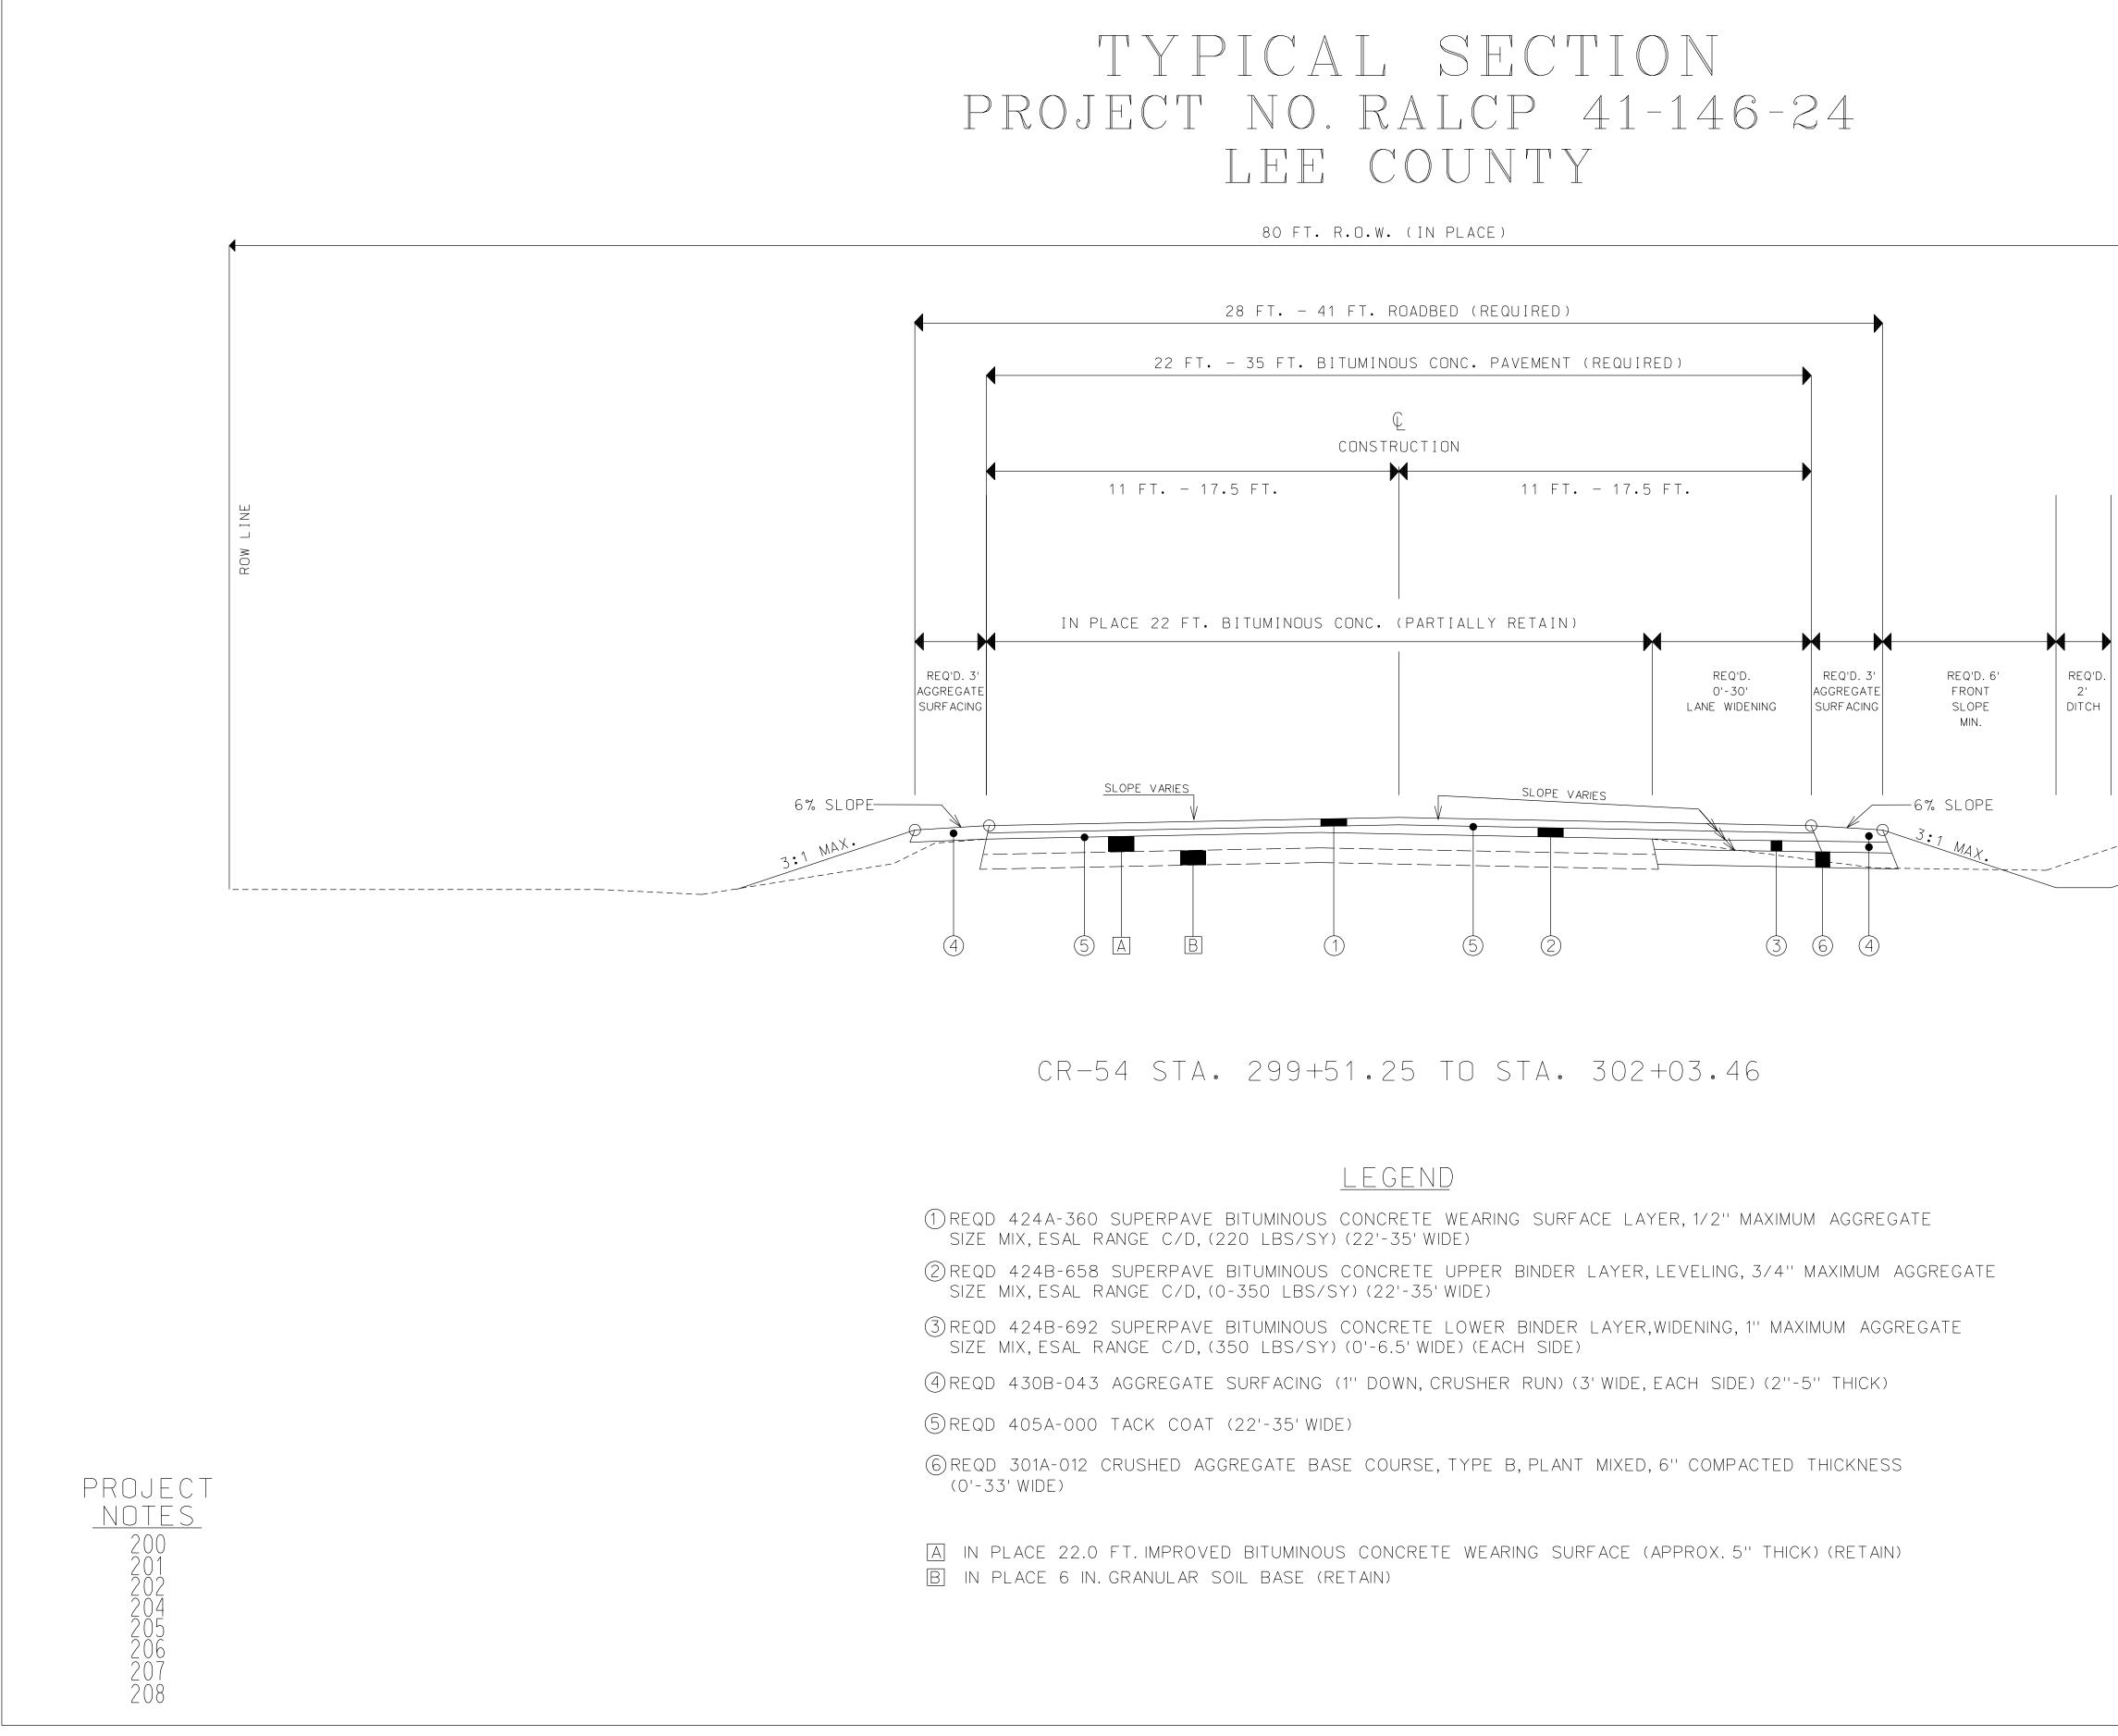

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	RALCP 41-146-24	2025	2E
ROW LINE			
3:1 MAX.			
-			
	NOT TO SO	CALE	

DETAIL FOR F BEGIN
50 FT MIN. OR AS DIRE
BY THE ENGINEER
REMOVE - NOTCH EXISTING ASPHA TO A DEPTH OF 2.00''
NOTE: REMOVE EXISTING PAVEMENT
BITUMINOUS CONCRETE WEARII
DISPOSAL OF THE IN-PLACE F
OBLIGATION OF ITEM NO. 424.

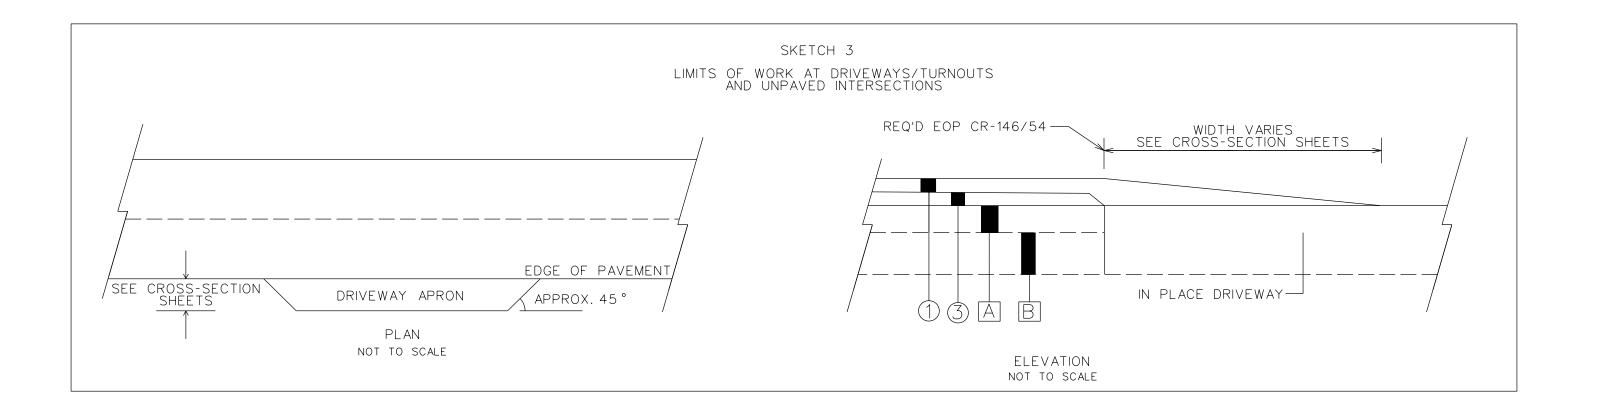


		LEGEND
NO.	ITEM NO. UNIT	DESCRIPTION
1	424A-360 TON	REQUIRED SUPERPAVE BITUMINOUS CONCRETE WEARING SURFACE LAYER, 1/2'' Maximum aggregate size Mix, esal range C/D (220 lb/sy)
3	424B-692 TON	REQUIRED SUPERPAVE BITUMINOUS CONCRETE LOWER BINDER LAYER, WIDENING, 1" MAXIM AGGREGATE SIZE MIX, ESAL RANGE C/D (APPROXIMATELY 350 LB/SY)

A B

PROJECT NOTES 200 201

## TYPICAL SECTION PROJECT NO. RALCP 41-146-24 LEE COUNTY

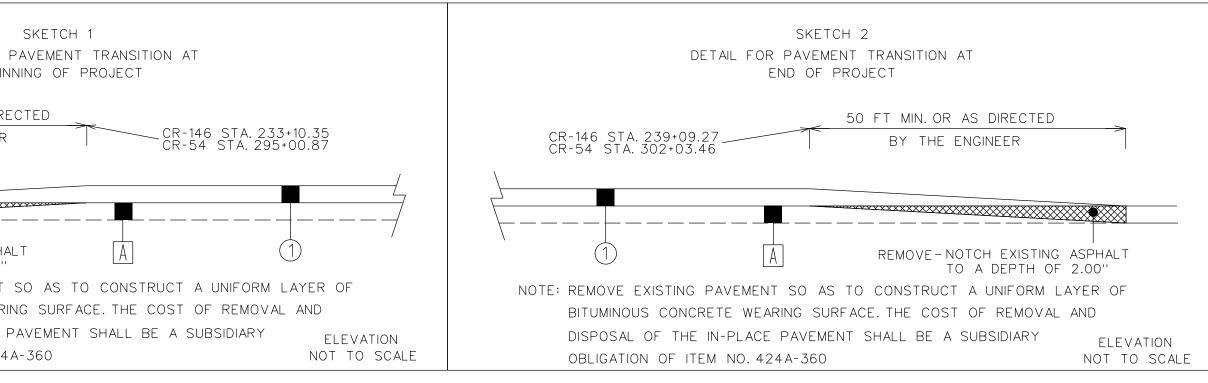

IN PLACE: BITUMINOUS PAVEMENT (FULL WIDTH) (RETAIN) IN PLACE: 8" GRANULAR SOIL BASE (FULL WIDTH) (RETAIN)

REFERENCE Project no.	FISCAL YEAR	SHEET' NO.
RACLP 41-146-24	2025	2F

KIMUM

200 THE TYPICAL SECTIONS ARE TO BE USED IN CONJUNCTION WITH THE PAVING LAYOUT SHEET TO ESTABLISH THE CORRECT PAVEMENT WIDTHS, TAPER LE 201 ROADBED STABILIZATION OF THE SUBGRADE IS REQUIRED WHERE THE ROAD IS BEING WIDENED 3 FEET OR MORE. THE SUBGRADE IS TO BE COMPACTED INSPECTED BY PROOF ROLLING, UNDER THE SUPERVISION OF THE ENGINEER, WITH A FULLY LOADED TRI-AXLE DUMP TRUCK (PROVIDED BY THE CONTRACT ANY AREA IDENTIFIED BY THE ENGINEER AS UNSATISFACTORY, SHALL BE EXCAVATED AND BACKFILLED WITH ITEM NO. 210D-021 BORROW EXCAVATION (A4 ITEM 305B-071. 300 CUBIC YARDS OF ITEM NO 210A-001 UNCLASSIFIED EXCAVATION (SPECIAL UNDERCUTTING) HAS BEEN ADDED FOR EXCAVATING UNSUIT

- DIRECTED BY THE ENGINEER.

- TO EXCEED 6 INCHES.
- 205 ALL WORK SHALL BE GRADED IN SUCH A WAY TO RESULT IN POSITIVE DRAINAGE TOWARD THE STORM SEWER SYSTEM.
- 206 SEE CROSS-SECTION SHEETS FOR CUT AND FILL SLOPES, AND PAVEMENT THICKNESS THAT FIT THE FIELD CONDITIONS.
- FACE. THE COST SHALL BE A SUBSIDIARY OBLIGATION OF PAY ITEM 210A-000 UNCLASSIFIED EXCAVATION.
- 300 ALL EROSION AND SEDIMENT CONTROL MEASURES ARE TO BE USED AS DIRECTED BY THE ENGINEER.
- ENGINEER.

- OBLIGATION OF ITEM 710B-001, ROADWAY SIGN POST.
- 306 212 SQUARE YARDS OF PLANING EXISTING PAVEMENT, ITEM 408A-052, HAS BEEN SET UP FOR PLANING THE EXISTING AND NEW PAVEMENT TO ACCOMMODATE THE COMBINATION CURB AND GUTTER IN THE CENTRAL, SPLITTER, AND RAISED ISLANDS.
- WILL BE INSTALLED.
- PREMIER STRAW/COCONUT BLEND SHALL BE REQUIRED.

## PROJECT NOTES PROJECT NO. RALCP 41-146-24 LEE COUNTY

202 THE CONCRETE TRUCK APRON SHALL BE HERRINGBONE PATTERN, SLATE GRAY COLOR, AND SEALED WITH A SEMI-GLOSS FINISH. ALL OTHER EXPOSED CONCRETE TO HAVE FINE BROOM FINISH. CONCRETE COLORING SHALL BE ADDED AT THE CONCRETE PLANT. NO. 3 REINFORCING BAR SHALL BE PLACED WITHIN THE CONCRETE TRUCK APRON AT A 12 INCH ON-CENTER GRID PATTERN, 2 INCHES UP FROM THE BOTTOM OF THE SLAB. STAMPING, COLORING, SEMI-GLOSS FINISH, AND REBAR TO BE A SUBSIDIARY OBLIGATION OF ITEM 614B-000, REINFORCED SLOPE PAVING. 203 THE CONTRACTOR SHALL PROVIDE SLOPED ENDS ON ALL CURB AND GUTTER TURN-OUTS. THE COST OF THIS TRANSITION SHALL BE A SUBSIDIARY OBLIGATION OF PAY ITEM 623C-003. 204 ALL REQUIRED BORROW EXCAVATION (FILL MATERIAL) SHALL BE PAID FOR AS ITEM 210D-021 AND MEET OR EXCEED SOIL CLASSIFICATION A4. BORROW EXCAVATION SHALL BE PLACED IN LIFTS NOT

207 NOTCHING CRUSHED AGGREGATE BASE COURSE FOR THE COMBINATION CURB AND GUTTER, TYPE C SHALL BE A SUBSIDIARY OBLIGATION OF ITEM 301A-012 CRUSHED AGGREGATE BASE COURSE. 208 WHERE PORTIONS OF EXISTING ASPHALT PAVEMENT ARE TO REMAIN IN PLACE AND ABUT OR JOIN THE NEW WORK, THE EXISTING PAVEMENT SHALL BE SAW CUT TO A NEAT LINE WITH A VERTICAL

301 EXCESS CUT MATERIAL, IF ANY, SHALL BECOME THE RESPONSIBILITY OF THE CONTRACTOR AND SHALL BE REMOVED FROM THE SITE UNLESS OTHERWISE APPROVED TO BE PLACED ON SITE BY THE

302 300 TONS OF ITEM NO.2318-004 ROADBED STABILIZING MATERIAL, ALDOT #57 HAS BEEN ADDED FOR STABILIZING THE ROADBED IN ANY AREAS WHERE THE ROAD IS WIDENED MORE THAN 3 FEET. THE STABILIZING MATERIAL SHALL BE PLACED AT RATES AS DIRECTED BY THE ENGINEER AND MIXED WITH THE SUBGRADE MATERIAL TO A DEPTH OF 10 INCHES. 303 26 CUBIC YARDS OF ITEM 210A-000 UNCLASSIFIED EXCAVATION HAS BEEN ESTABLISHED FOR REMOVING THE EXISTING ROAD BED FROM STATION 300+25 TO STATION 302+00 OF LEE RD.54. 304 ALL SIGN POST INSTALLED IN CONCRETE SHALL BE INSTALLED PER THE BREAKAWAY SIGN POST DETAIL ON THE SIGNAGE AND STRIPING DETAIL SHEET. COST TO BE A SUBSIDIARY

305 200 TONS OF COURSE AGGREGATE, ITEM 305B-071, HAS BEEN SET UP TO BE PLACED IN SOFT OR YIELDING AREAS AS DIRECTED BY THE ENGINEER.

307 95 TONS OF BITUMINOUS CONCRETE WEARING SURFACE LAYER, 1/2" MAX. AGGREGATE SIZE MIX, ITEM 424A-360, HAS BEEN ADDED TO THE QUANTITIES FOR PAVING DRIVEWAY TURNOUTS. 308 30 TONS OF CRUSHER RUN, ITEM 4308-043, HAS BEEN ADDED TO THE QUANTITIES FOR FLUSHING THE SHOULDERS 3' WIDE, DURING CONSTRUCTION, IN THE AREAS THE COMBINATION CURB AND GUTTER

309 560 SQUARE YARDS EROSION CONTROL PRODUCT, TYPE C2, ITEM 659C-004, HAS BEEN ADDED TO THE QUANTITIES FOR PLACEMENT IN THE STORMWATER DITCHES. 8 FEET WIDE ROLLS OF AEC

	REFERENCE Project no.	FISCAL YEAR	SHEET NO.
	RALCP 41-146-24	2025	2 G
NGTHS AND TRANSITIONS			
NGTHS, AND TRANSITIONS.			
	THE ENGINEER 4	AND	
TO THE SATISFACTION OF			
TO THE SATISFACTION OF	YIELDING AREA		

800 THERE ARE NO KNOWN UTILITY CONFLICTS INVOLVED IN THE CONSTRUCTION OF THIS PROJECT. LISTED BELOW ARE THE UTILITY OWNERS:

SPECTRUM 2740 ENTERPRISE DRIVE OPELIKA,AL 368Ø1 888-406-7063

AT&T 1801 AIRPORT ROAD OPELIKA,AL 368Ø1 334-741-7856

ALABAMA POWER 9 STAFFORD ROAD. PHENIX CITY,AL 3687Ø 334-214-5052

SPIRE P.O.BOX 2224 BIRMINGHAM, AL 35246 1-800-292-4008

- 900 NPDES PERMIT COVERAGE IS NOT REQUIRED FOR THIS PROJECT
- ON THE RIGHT-OF-WAY.

## PROJECT NOTES PROJECT NO. RALCP 41-146-24 LEE COUNTY

BEAUREGARD WATER AUTHORITY 7430 AL HWY 51 OPELIKA, AL 36804 334-749-4900

OPELIKA WATER 4055 WATER STREET OPELIKA, AL 368Ø1 334-705-5500

ZAYO 2030 POWERS FERRY RD, SUITE 306 ATLANTA, GA 3Ø339 866-364-6Ø33

801 IT SHALL BE THE CONTRACTOR'S RESPONSIBILITY TO DETERMINE THE EXACT LOCATION OF ALL UNDERGROUND UTILITIES BEFORE COMMENCING WORK. THE CONTRACTOR AGREES TO BE FULLY RESPONSIBLE FOR ANY AND ALL DAMAGES WHICH MIGHT BE OCCASIONED BY HIS FAILURE TO EXACTLY LOCATE AND PRESERVE ANY AND ALL UNDERGROUND UTILITIES.

802 10 EACH OF VALVE BOX RESETS, ITEM 641S-500, HAS BEEN PROVIDED IN THE QUANTITIES FOR RAISING WATER VALVE BOXES TO THE PROPER FINISHED GRADE ELEVATIONS.

901 THERE SHALL BE NO FUEL TANKS STORED ON THE RIGHT-OF-WAY, IN ADDITION, NO FUEL TRUCKS OR VEHICLES TRANSPORTING CHEMICALS, FERTILIZERS, ETC. SHALL BE LEFT UNATTENDED

REFERENCE Project no.	FISCAL YEAR	SHEET NO•	
RALCP 41-146-24	2025	2H	

			SUMMARY OF QUANTITIES	RA	REFERENCE PROJECT NO. LCP 41-146-24 2025 3
			$\sim$		
			PROJECT NO. RALCP 41-146-24		
			LEE COUNTY		
TOTAL	ITEM NO.	UNIT	DESCRIPTION	PROJECT NOTES	
<u>QTY.</u> 32	206D-000	LINEAR FOOT	REMOVING PIPE		-
300		CUBIC YARDS	UNCLASSIFIED EXCAVATION	3Ø1, 3Ø3	
300	210A-001	CUBIC YARDS	UNCLASSIFIED EXCAVATION (SPECIAL UNDERCUTTING)	3Ø1	
600	21ØD-Ø21	CUBIC YARDS	BORROW EXCAVATION (LOOSE TRUCKBED MEASUREMENT)(A4 OR BETTER)	2Ø4	
65	214A-ØØØ	CUBIC YARDS	STRUCTURE EXCAVATION	3Ø1	
5	230A-000	ROADBED STATION	ROADBED PROCESSING	2Ø1	
300	231B-004	TON	ROADBED STABILIZING MATERIAL, ALDOT #57	3Ø2	
1618	3Ø1A-Ø12	SQUARE YARD	CRUSHED AGGREGATE BASE COURSE, TYPE B, PLANT MIXED 6" COMPACTED THICKNESS		
200	3Ø5B-Ø71	TON	COURSE AGGREGATE, SECTION 801, FOR MISCELLANEOUS USE	3Ø5	
365	405A-000	GALLON	TACK COAT		
212	408A-052	SQUARE YARD	PLANING EXISTING PAVEMENT (APPROXIMATELY 2.0" THRU 8.0" THICK	3Ø6	
646	424A-36Ø	TON	SUPERPAVE BITUMINOUS CONCRETE WEARING SURFACE LAYER, 1/2" MAXIMUM AGGREGATE SIZE MIX, ESAL RANGE C/D	3Ø7	
202	424B-658	TON	SUPERPAVE BITUMINOUS CONCRETE UPPER BINDER LAYER, LEVELING, 3/4" MAXIMUM AGGREGATE SIZE MIX, ESAL RANGE C/D		
245	424B-692	TON	SUPERPAVE BITUMINOUS CONCRETE LOWER BINDER LAYER, WIDENING,1" MAXIMUM AGGREGATE SIZE MIX,ESAL RANGE C/D		
150	43ØB-Ø43	TON	AGGREGATE SURFACING (1" DOWN, CRUSHER RUN)	3Ø8	
99	450A-022	SQUARE YARDS	PLAIN CEMENT CONCRETE PAVEMENT, 14 INCHES THICK		
232	535A-Ø78	LINEAR FOOT	15" SIDE DRAIN PIPE (CLASS 3 R.C.)		
1	600A-000	LUMP SUM	MOBILIZATION		
48	614A-ØØØ	CUBIC YARDS	SLOPE PAVING		
79	614B-ØØØ	CUBIC YARDS	REINFORCED SLOPE PAVING (TRUCK APRON)	202	
162	623B-ØØ1	LINEAR FOOT	CONCRETE CURB, TYPE N SPECIAL		
110	623B-121	LINEAR FOOT	CONCRETE CURB, TYPE A (MODIFIED)		
239	623B-008	LINEAR FOOT	CONCRETE CURB, TYPE H (MODIFIED)		
1060	623C-ØØ3	LINEAR FOOT	COMBINATION CURB AND GUTTER, TYPE C (MODIFIED)	2Ø3	
10	6415-500	EACH	VALVE BOX RESET	8Ø2	_
66	650B-000	CUBIC YARD	TOPSOIL FROM STOCKPILES		
2	652A-100	ACRE	SEEDING	300	
2	656A-Ø1Ø	ACRE	MULCHING	300	
560	6590-004	SQUARE YARD	EROSION CONTROL PRODUCT, TYPE C2	300,309	
200	$\frac{665J-002}{0000}$	LINEAR FOOT	SILT FENCE DEMOVAL	300	
200	6650-001	LINEAR FOOT	SILT FENCE REMOVAL	300	

					REFERENCE FISCAL PROJECT NO. YEAR
			SUMMARY OF QUANTITIES	RAL	CP 41-146-24 2025
			PROJECT NO. RALCP 41-146-24		
			LEE COUNTY		
TOTAL				PROJECT	
QTY.	ITEM NO.	UNIT	DESCRIPTION	NOTES	
200	6650-002	LINEAR FOOT	WATTLE	300	
1	68ØA-ØØ1	LUMP SUM	GEOMETRIC CONTROLS		
2,900	7Ø1G-253	LINEAR FOOT	SOLID WHITE, CLASS 2, TYPE A TRAFFIC STRIPE (5" WIDE)		
3,650	7Ø1G-265	LINEAR FOOT	SOLID YELLOW, CLASS 2, TYPE A TRAFFIC STRIPE (5" WIDE)		
	7Ø1A-27Ø	MILE	SOLID WHITE, CLASS 2, TYPE A TRAFFIC STRIPE (10" WIDE)		
150	7Ø1B-Ø65	LINEAR FOOT	DOTTED CLASS 2, TYPE A TRAFFIC STRIPE (ROUNDABOUT 10" WIDE)		
	701C-001	MILE	SOLID TEMPORARY TRAFFIC STRIPE		
2100	701H-001	LINEAR FOOT	SOLID TRAFFIC STRIPE REMOVED (PLASTIC)		
1300	703A-002	SQUARE FOOT	TRAFFIC CONTROL MARKINGS, CLASS 2, TYPE A		
150 150	7Ø3C-ØØ1 7Ø3D-ØØ1	SQUARE FOOT	REMOVAL OF EXISTING TRAFFIC CONTROL MARKINGS OR LEGENDS (PLASTIC) TEMPORARY TRAFFIC CONTROL MARKINGS		
1500 95	7050-001 705A-030	SQUARE FOOT EACH	PAVEMENT MARKERS, CLASS A-H, TYPE 2-C		
260	705A-030	EACH	PAVEMENT MARKERS, CLASS A-H, TYPE 1-B		
15	705A-037	EACH	PAVEMENT MARKERS, CLASS A-H, TYPE 2-D		
150	705A-038	EACH	PAVEMENT MARKERS, CLASS A-H, TYPE 2-E		
28	71ØA-163	SQUARE FOOT	CLASS 10 ALUMINUM FLAT SIGN PANELS (TYPE XI BACKGROUND)		
195	71ØA-171	SQUARE FOOT	CLASS 4, ALUMINUM FLAT SIGN PANELS (TYPE IV BACKGROUND)		
244	71ØB-ØØ1	LINEAR FOOT	ROADWAY SIGN POST (#3 "U" CHANNEL GALVANIZED STEEL)	3Ø4	
1	7100-000	LUMP SUM	REMOVAL OF EXISTING ROADWAY SIGNS		
560	74ØB-ØØØ		CONSTRUCTION SIGNS		
150	7400-000	EACH	CHANNELIZING DRUMS		
200	740E-000	EACH	CONES (36 INCHES HIGH)		
1	7400-000	EACH	PILOT CAR		
4	742A-001	EACH	PORTABLE CHANGEABLE MESSAGE SIGN, TYPE 2		

				REQ
				SE
ROADWAY	STATION	SIDE	NO. OF POSTS	POST LENGTH (FT.) -
146	234+11	RT	1	12
146	235+20	MED	1	12
146	235+57	MED	1	12
146	235+65	RT	1	12
146	236+10	MED	1	1()
146	236+17	MED		10
146	236+28	MED		10
146	236+38	MED		
146	236+85			12
146	236+89	MED	1	12
146	237+24		1	12
146 E 4	238+43		1	10
54	295+97		1	12
54	297 + 36		1	
<u> </u>	<u>297+74</u> 297+79	NEU DT	1	
54	297+79 299+01		1	10
54	299+01 299+02		1	10
54	299+41		1	17
54	300+59		1	12
54	302+00		1	12
	SUBT TO		21	244

## SUMMARY OF QUANTITIES PROJECT NO. RALCP 41-146-23 LEE COUNTY

### EQUIRED GROUND MOUNTED ROADWAY SIGNS

SEE	SIGNAGE	AND	STRIPING	DETAIL	SHEET	
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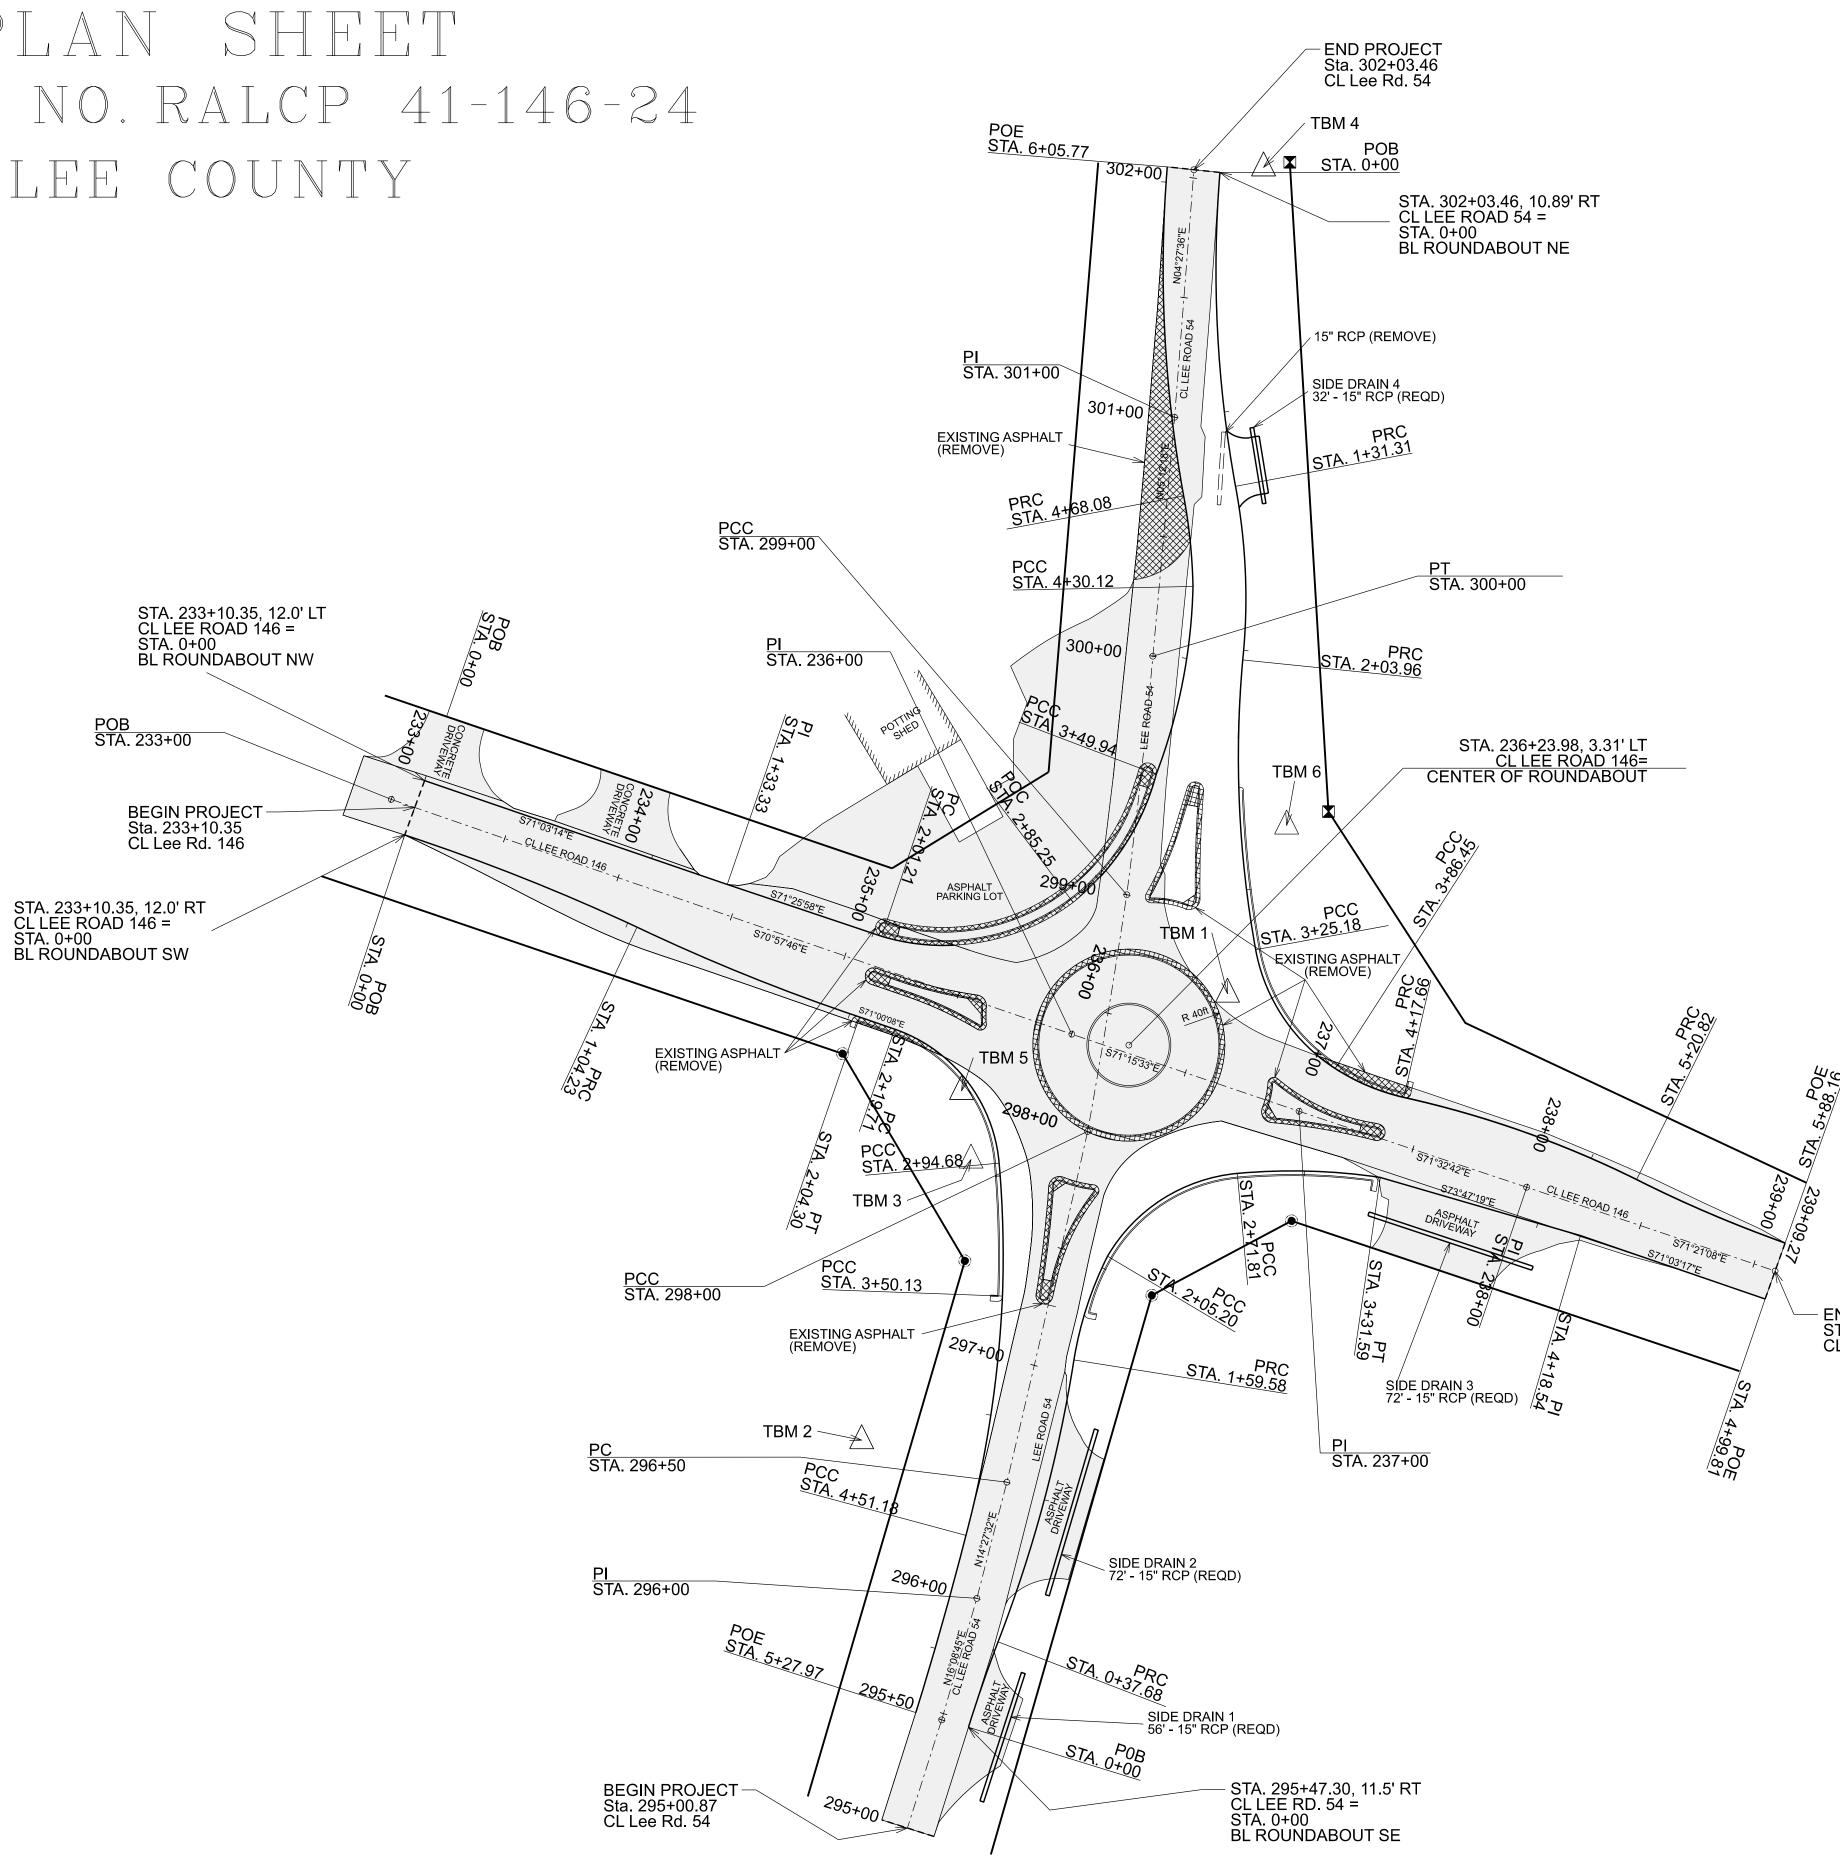
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THI( UNC . S	CK )) Q. FT.	SQ.FT.	SQ.FT.			
THI( UNC . S	CK )) Q. FT.	SQ.FT.	SQ.FT.			
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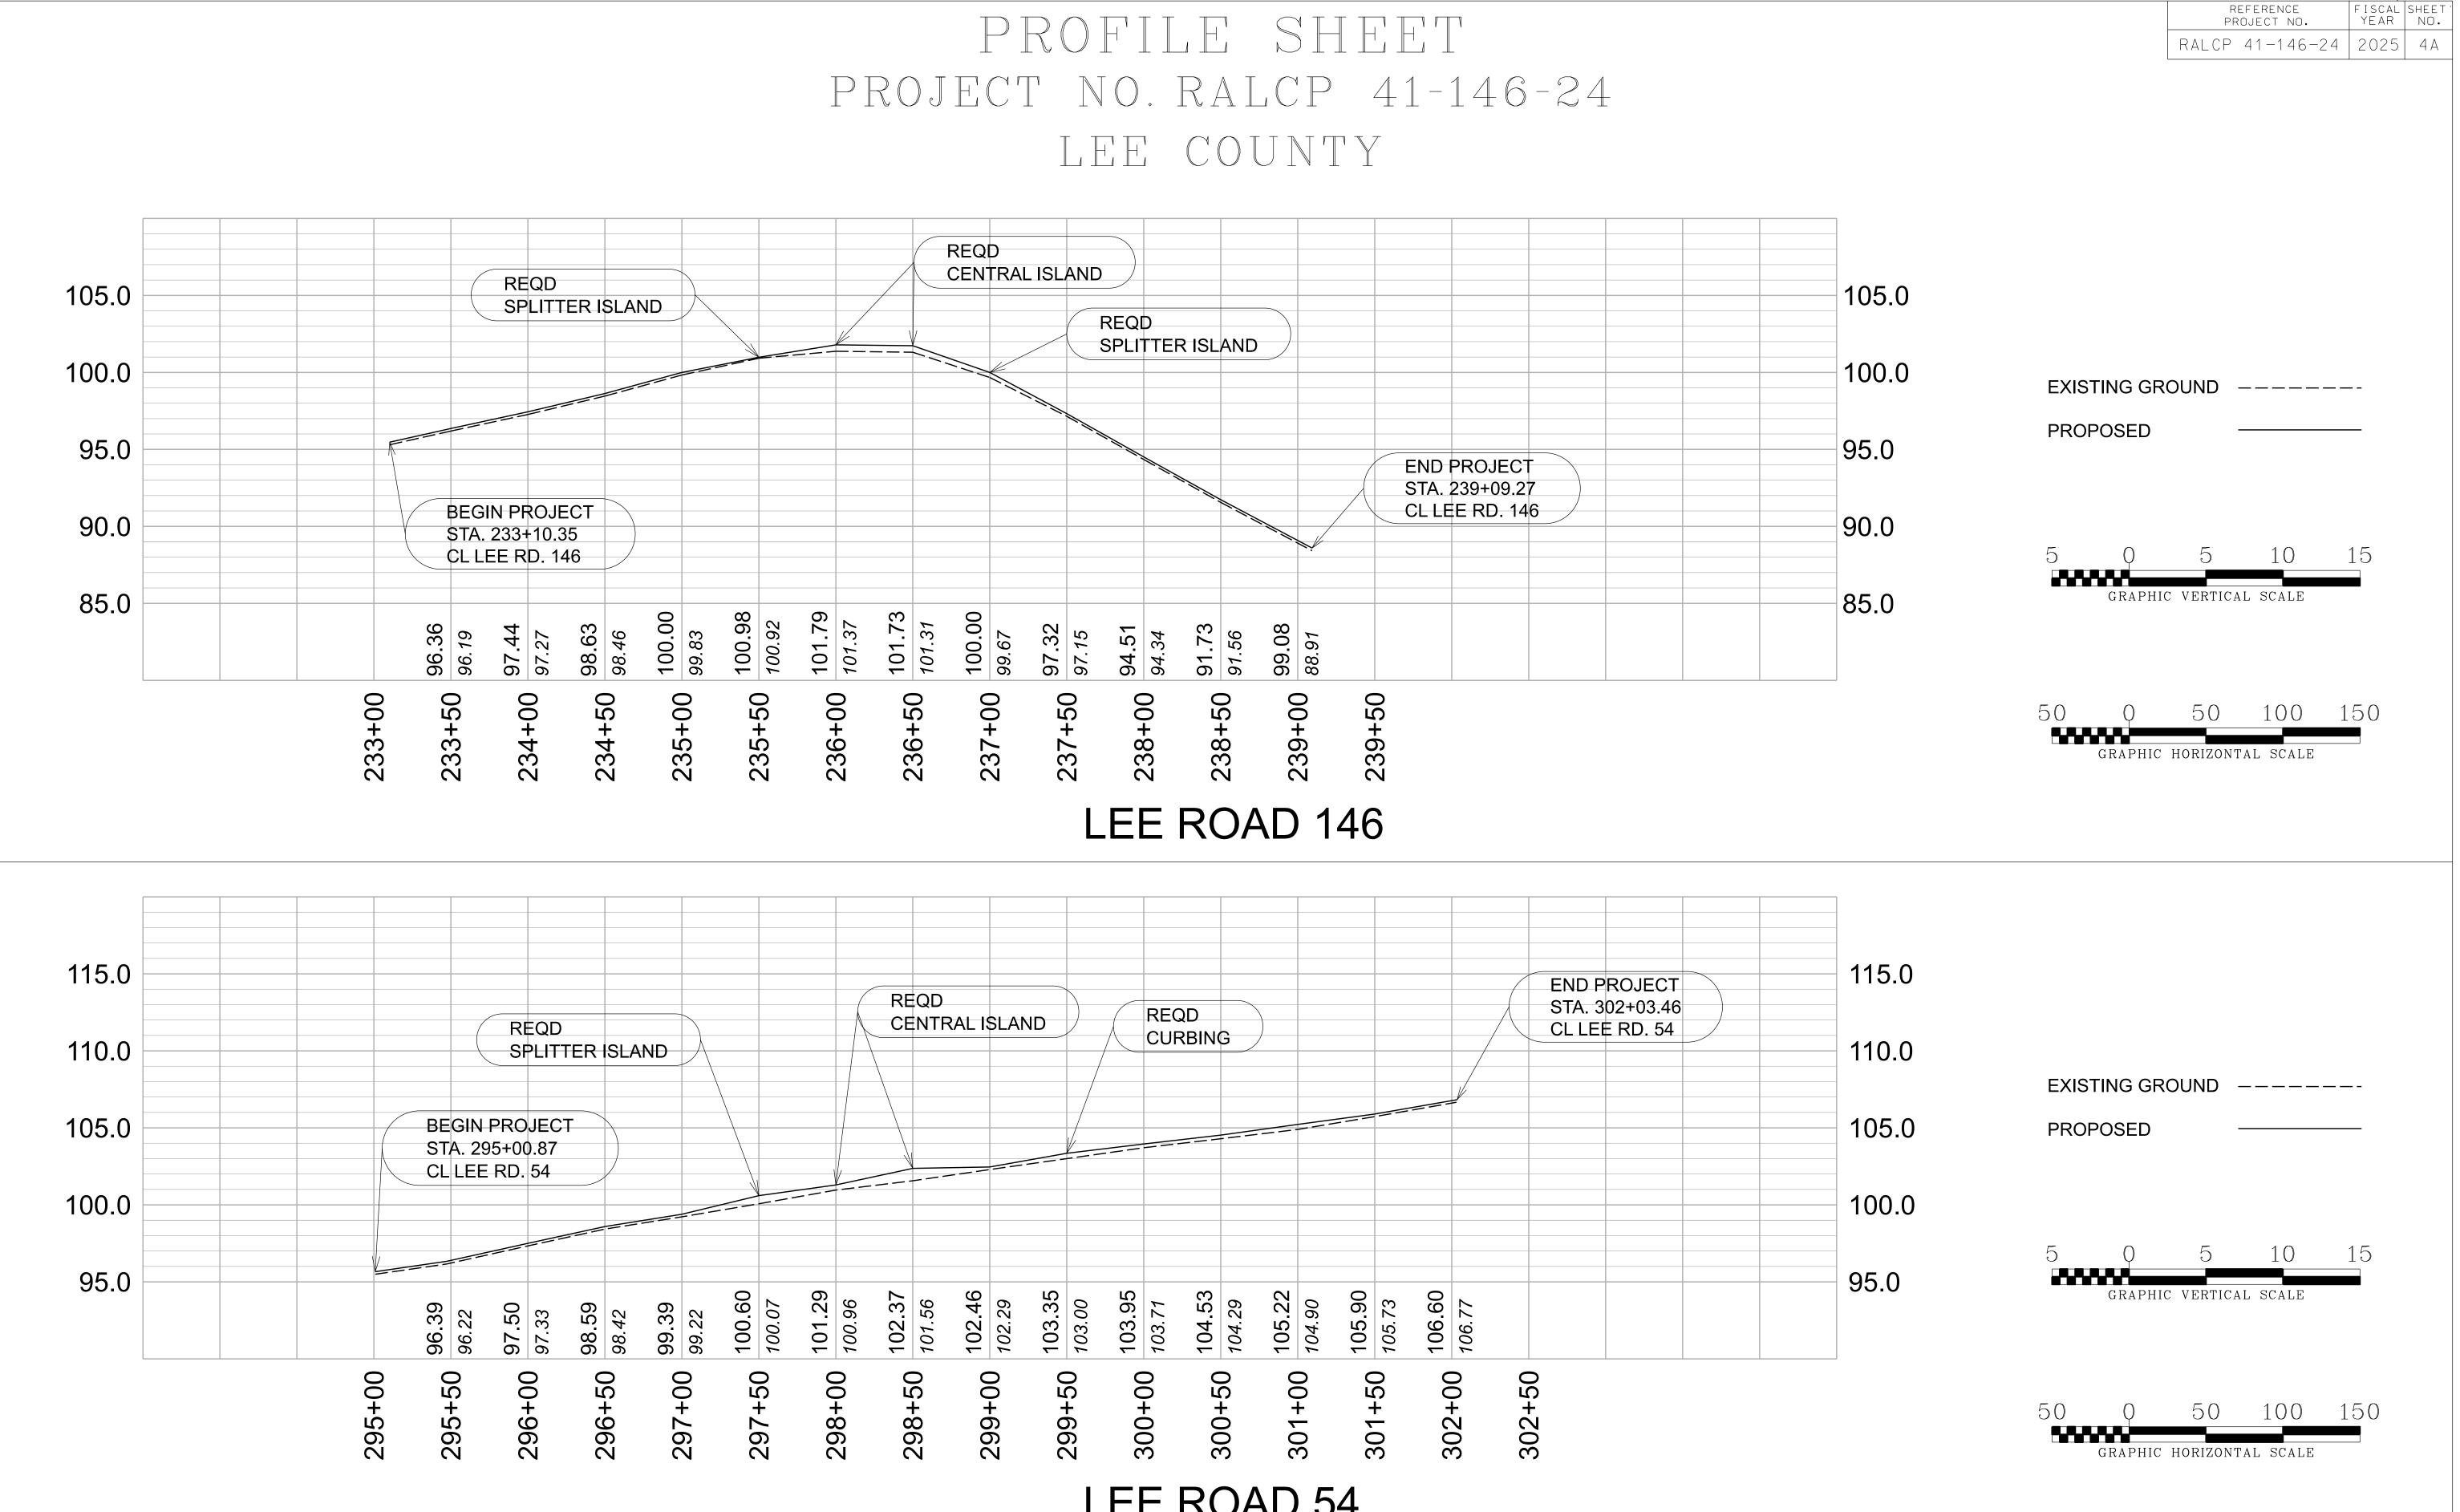
## PROJECT NOTES

3Ø4


## PLAN SHEET PROJECT NO. RALCP 41-146-24 LEE COUNTY




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D PROJECT A. 239+09.27 Lee Rd. 146				5	
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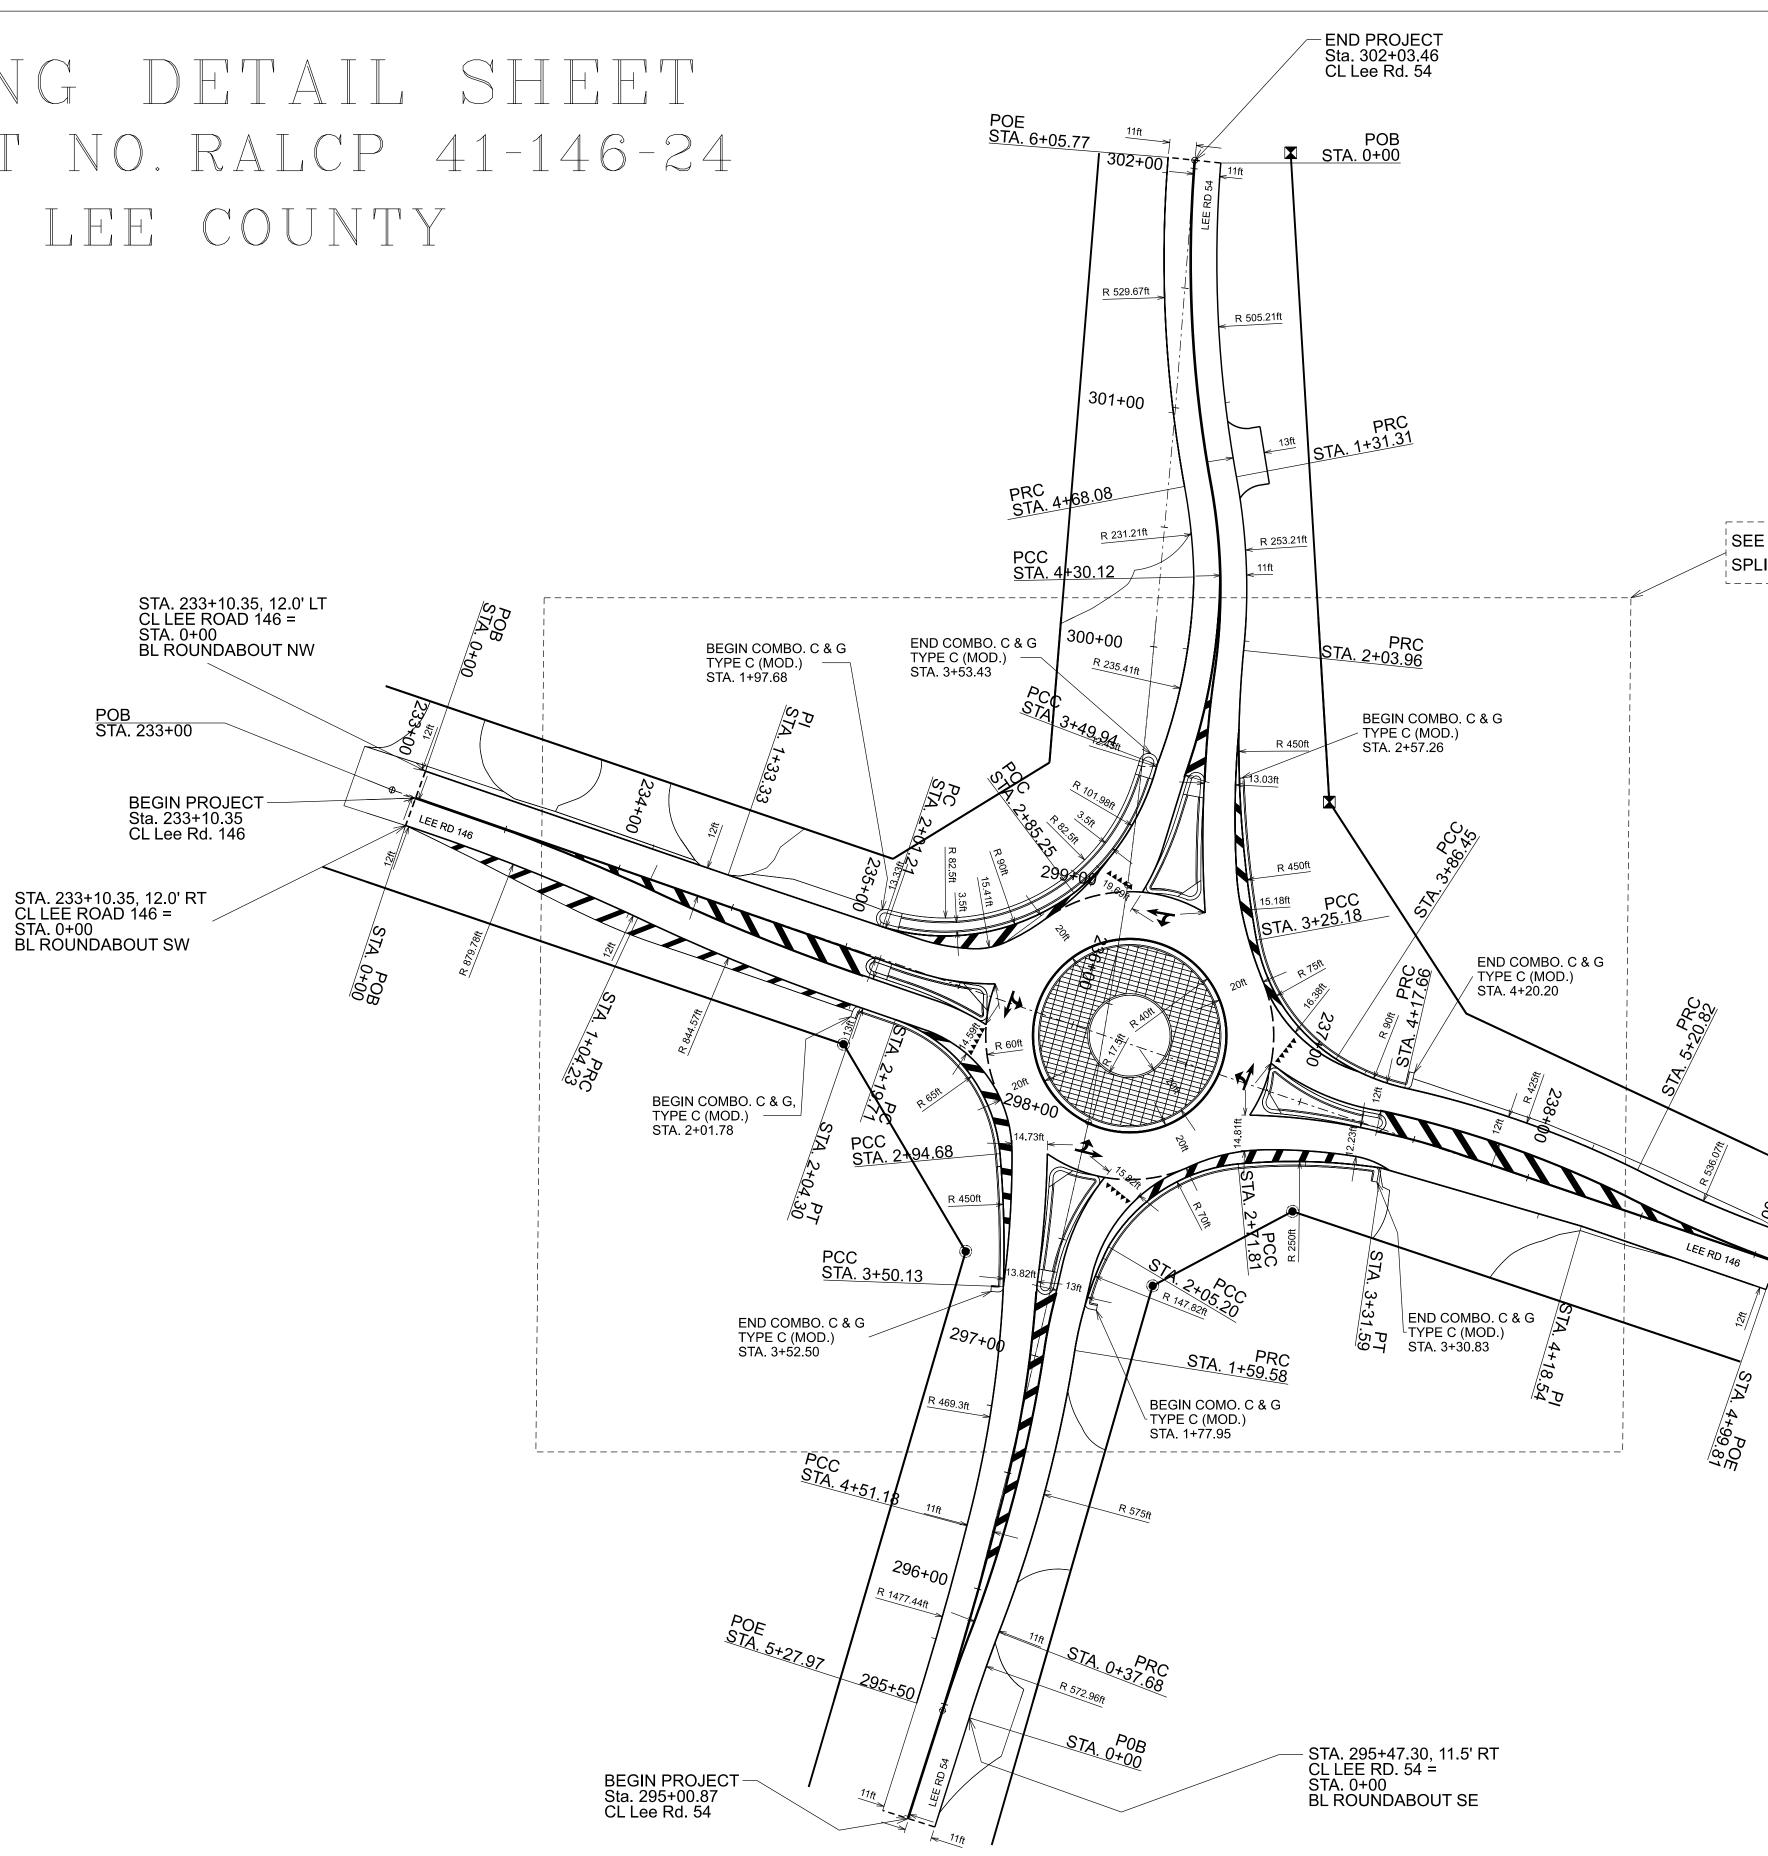
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## **BL ROUNDABOUT NE**


## PAVING DETAIL SHEET PROJECT NO. RALCP 41-146-24 LEE COUNTY



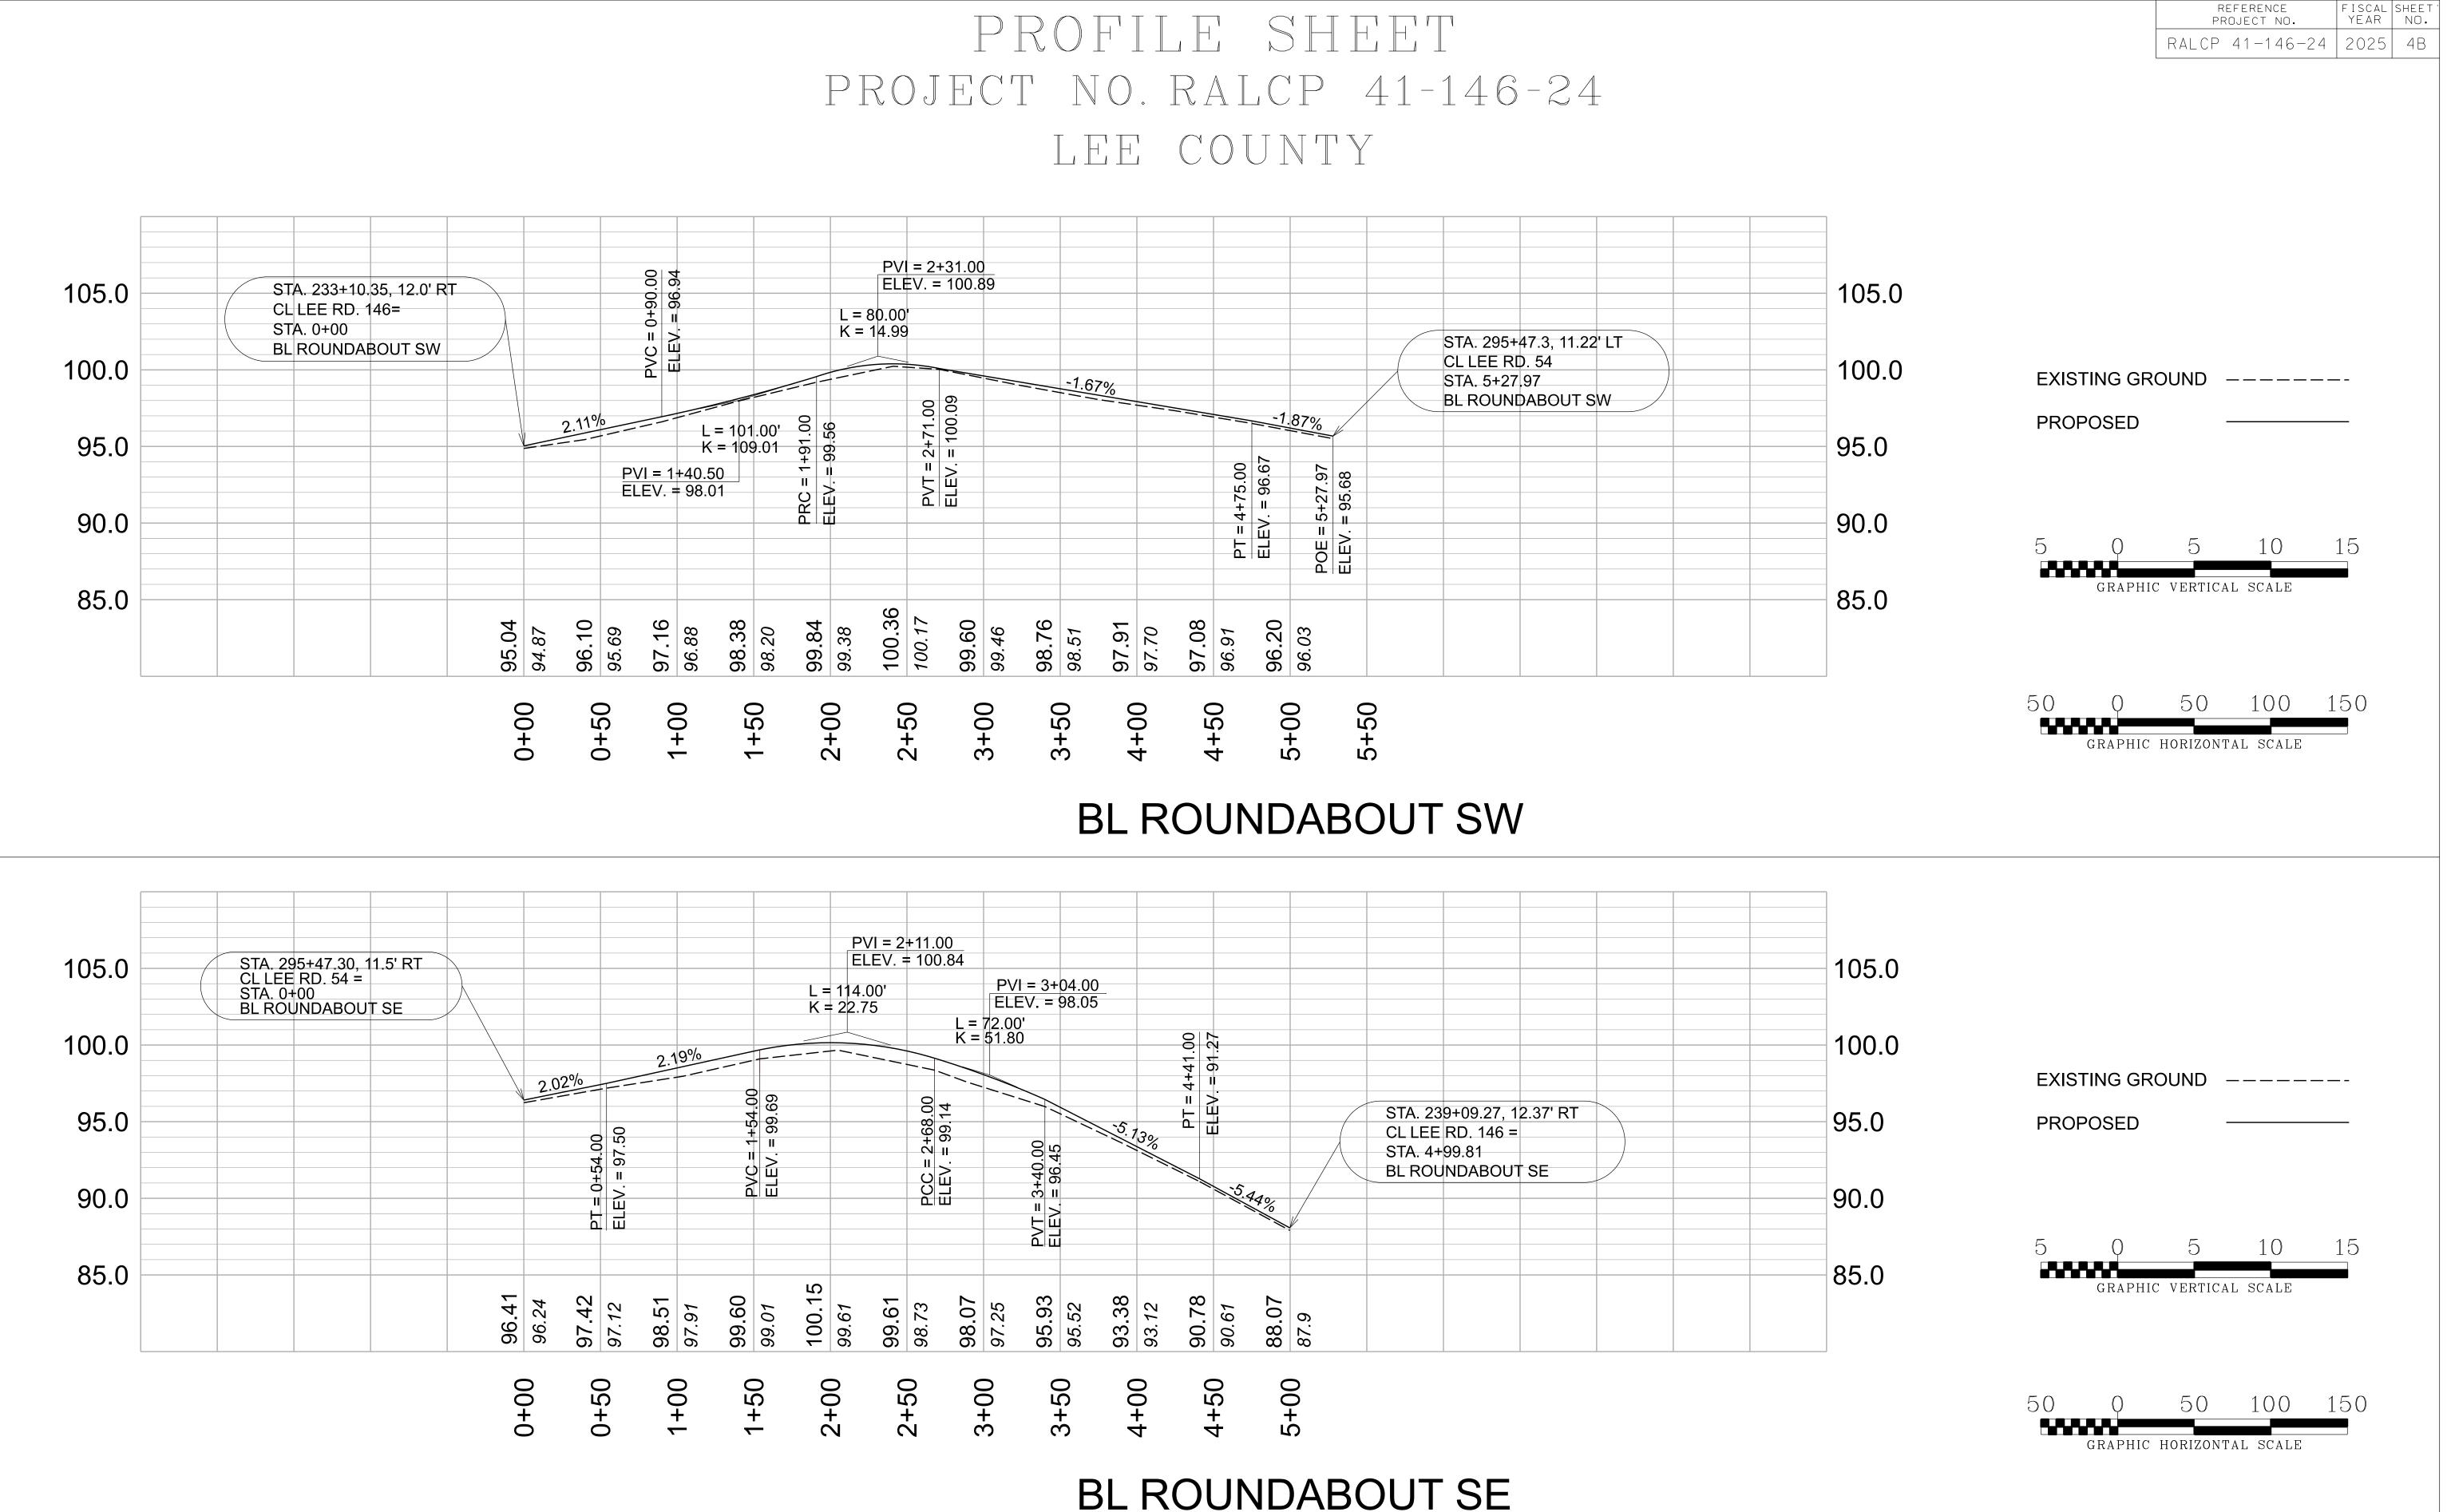

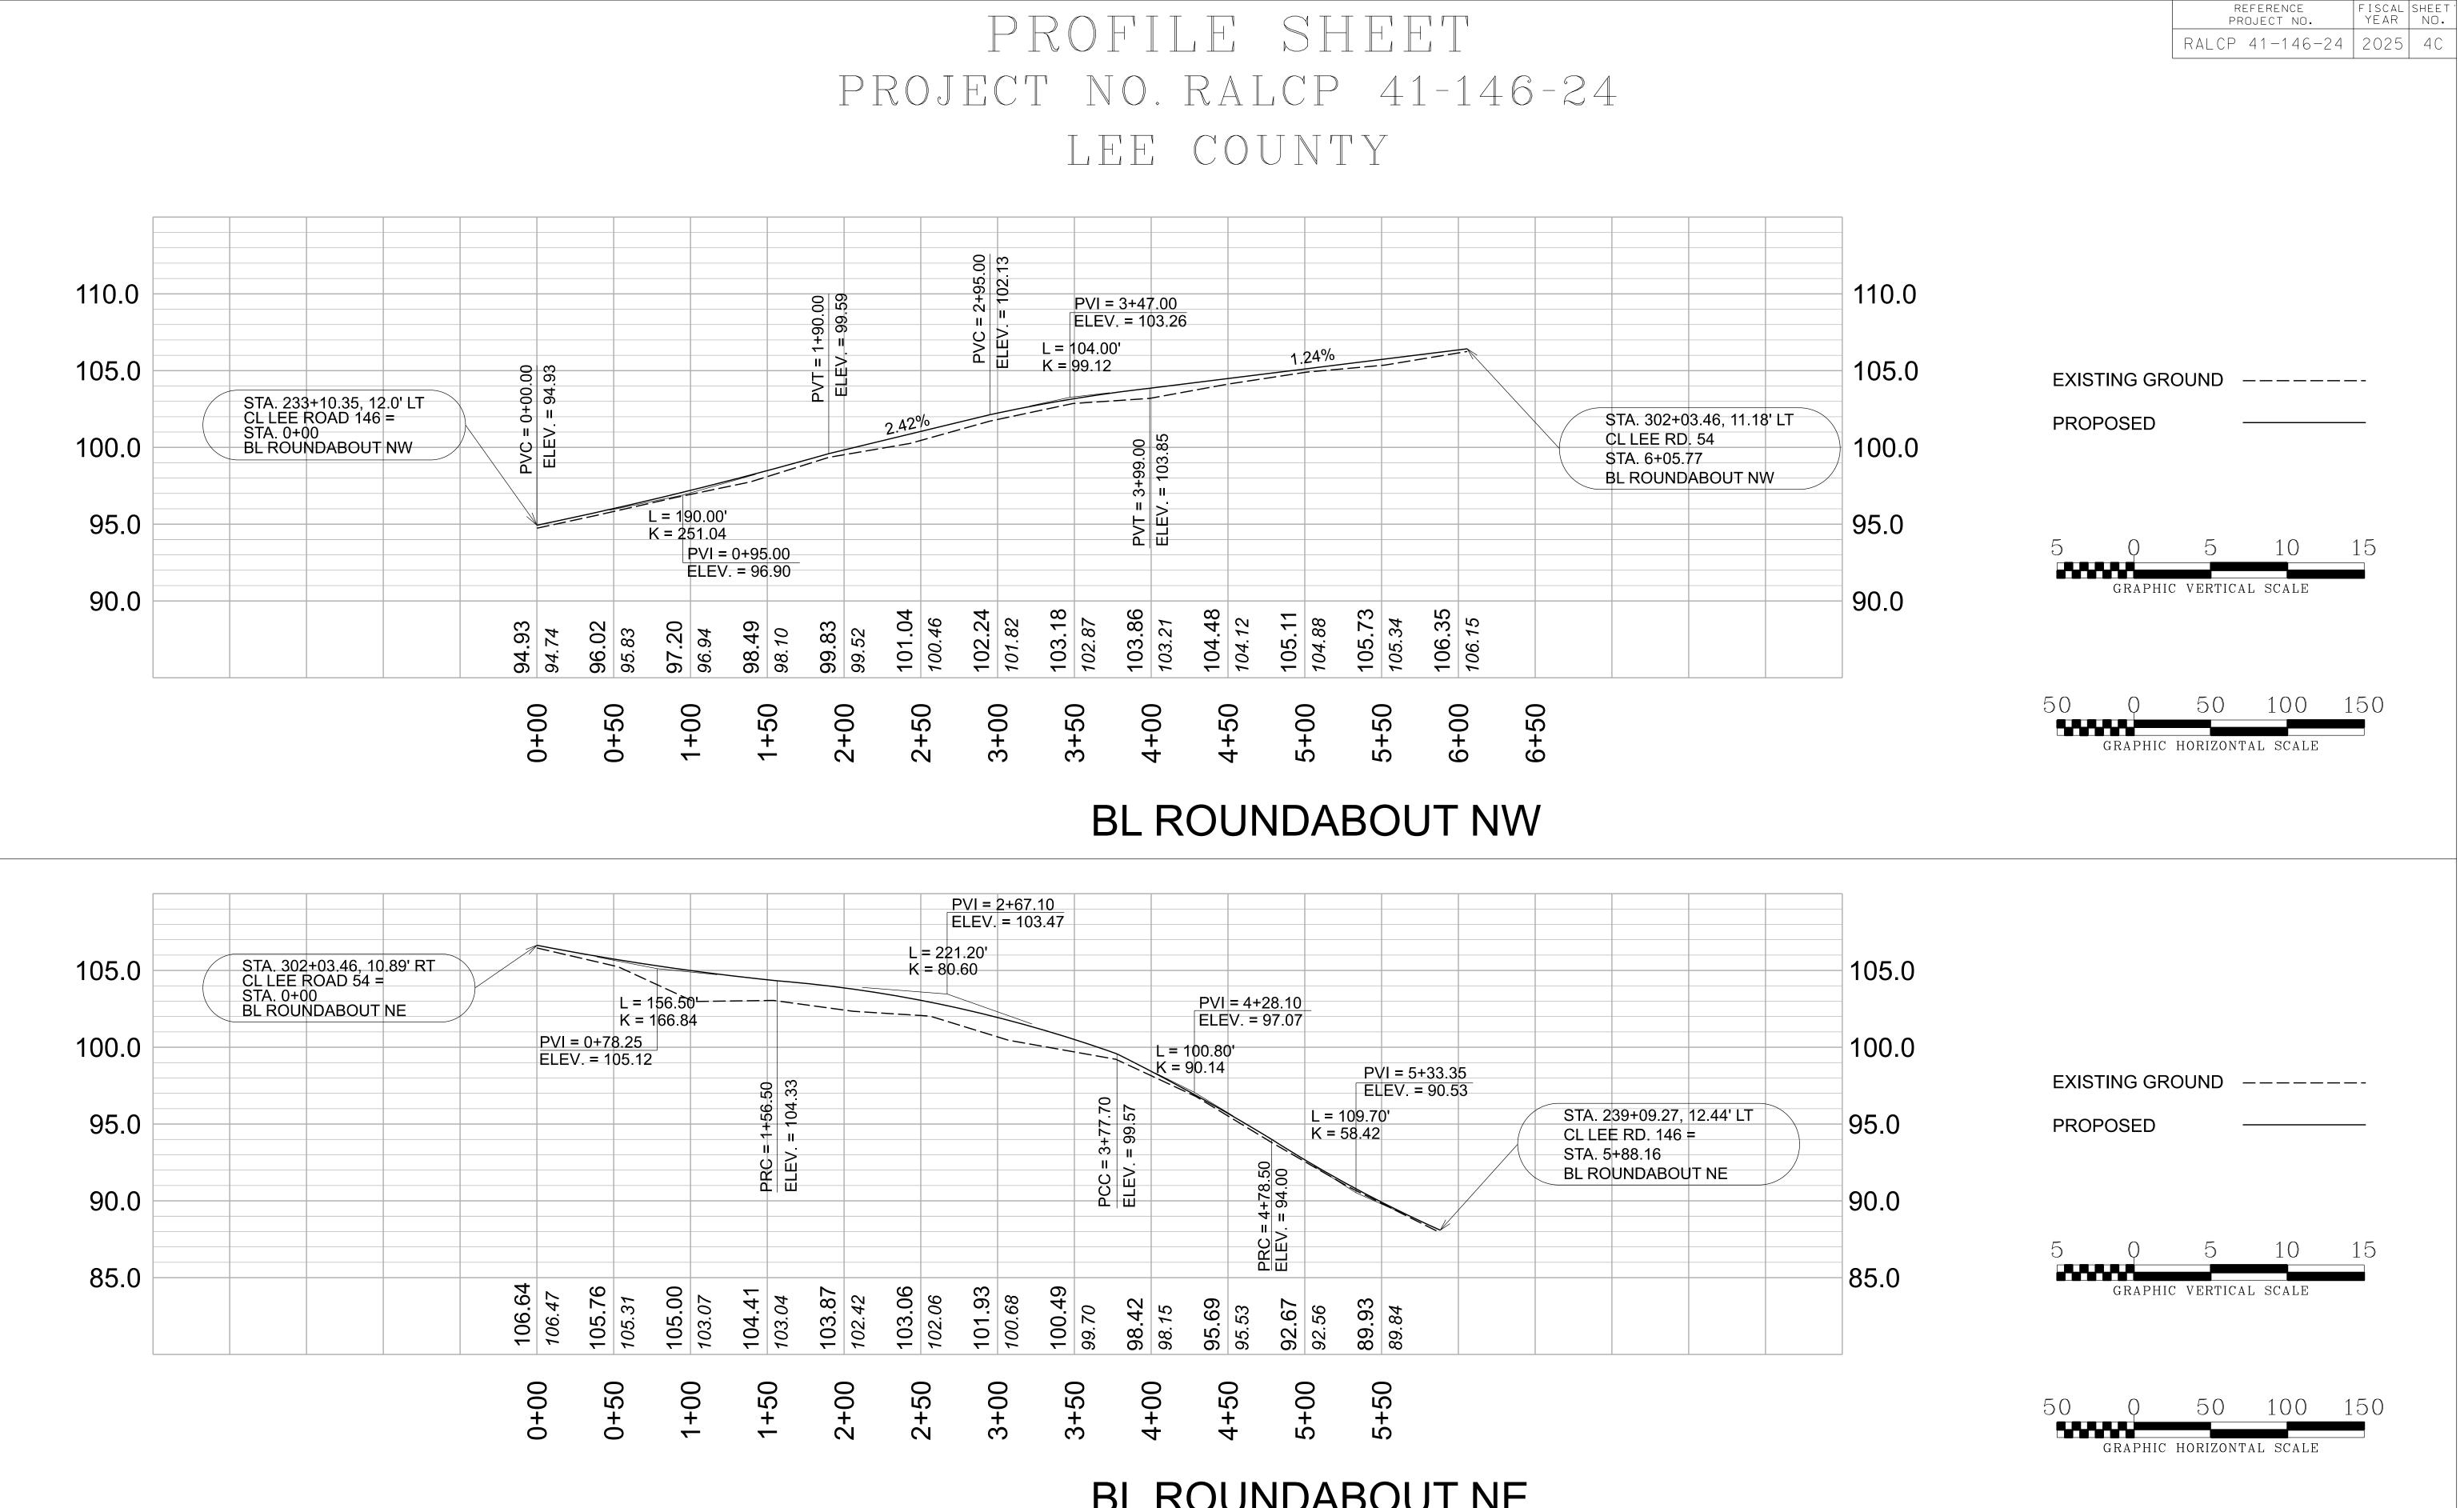
		F	REFERENC Project n P 41-14	10.	fiscal year 2025	sheet ' NO. 5
SHEET 5A AND 5B FOR ITTER ISLAND DETAILS						
49						
END PROJECT TA. 239+09.27 CL Lee Rd. 146					>	
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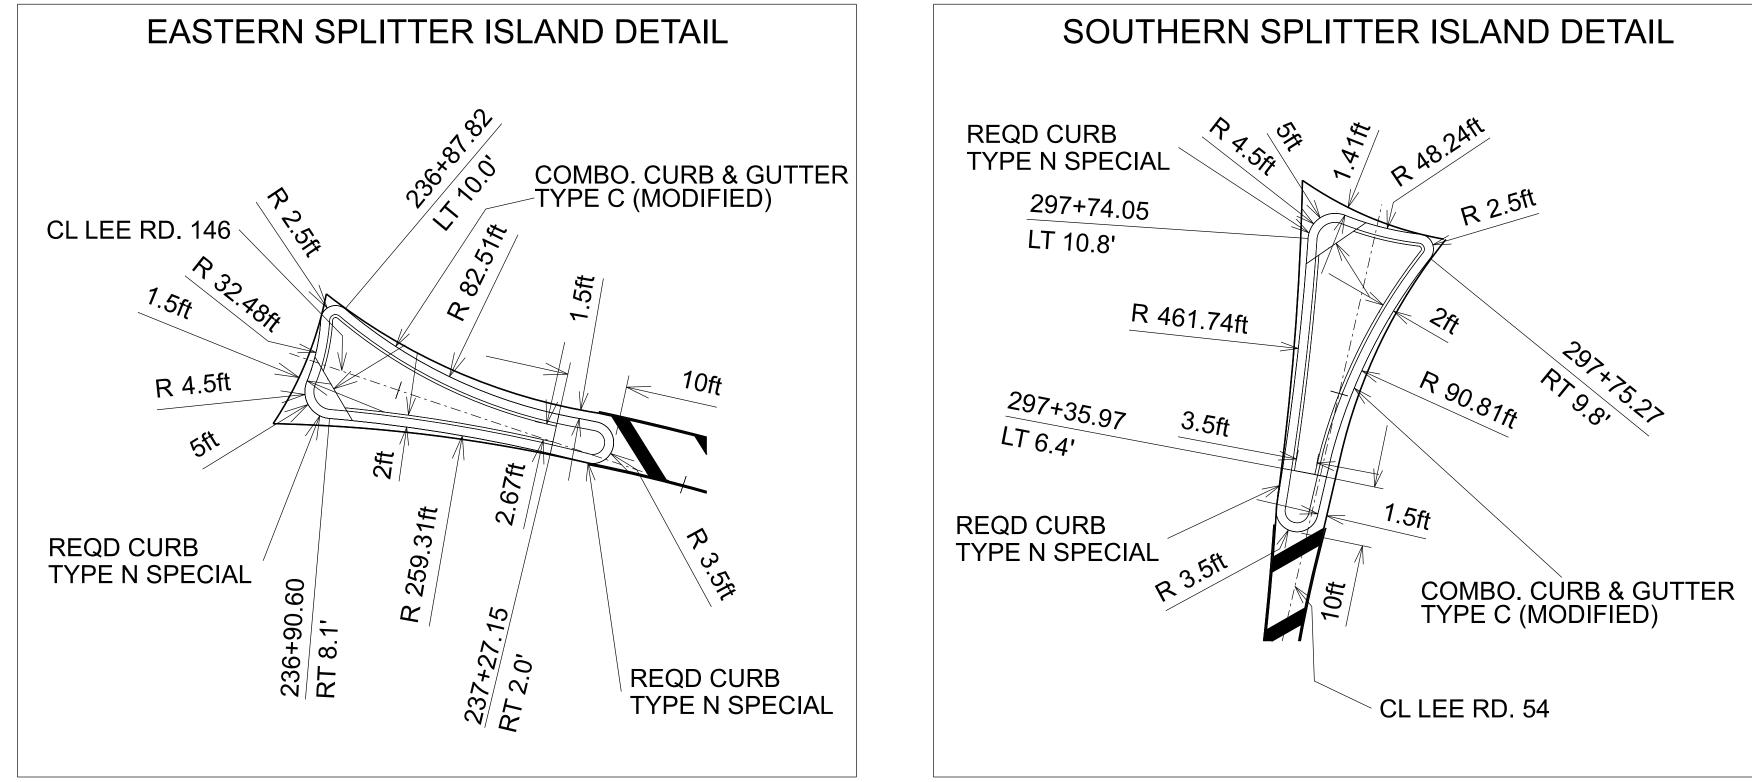
## PAVING DETAIL SHEET PROJECT NO. RALCP 41-146-24 LEE COUNTY

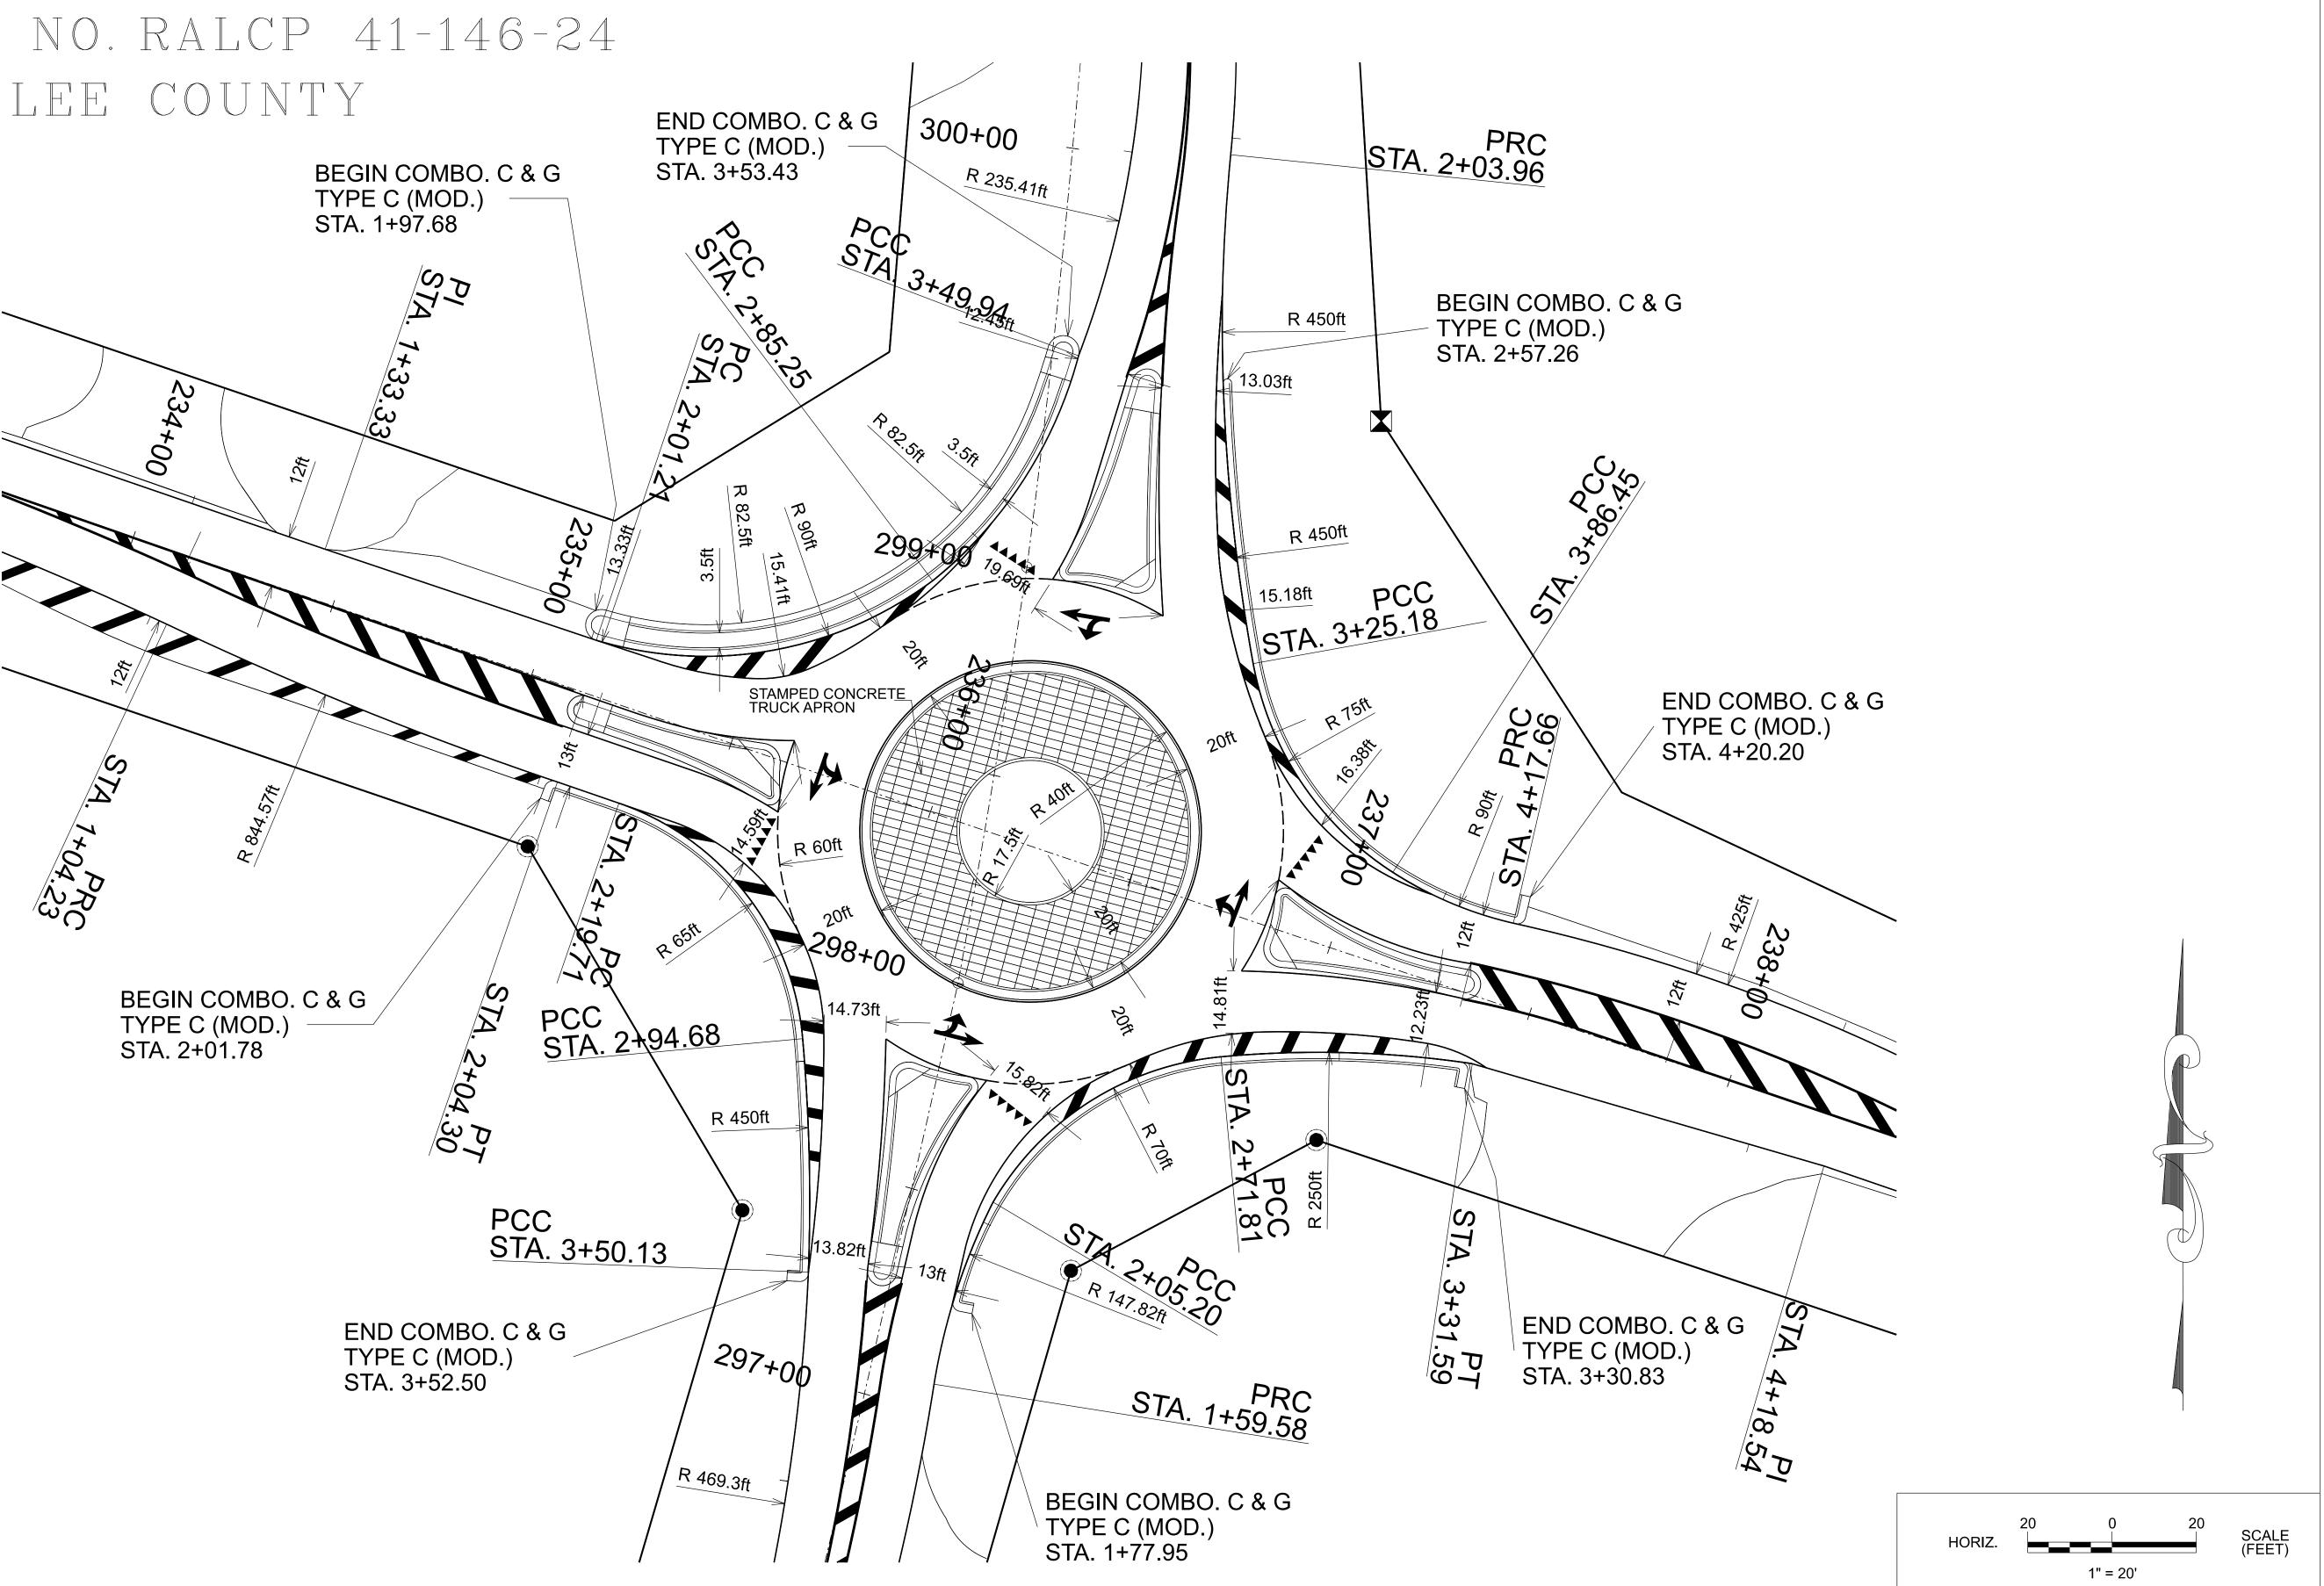

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RALCP 41-146-24 2025 5A	RALCP	9 41-146-24	2025	5 A






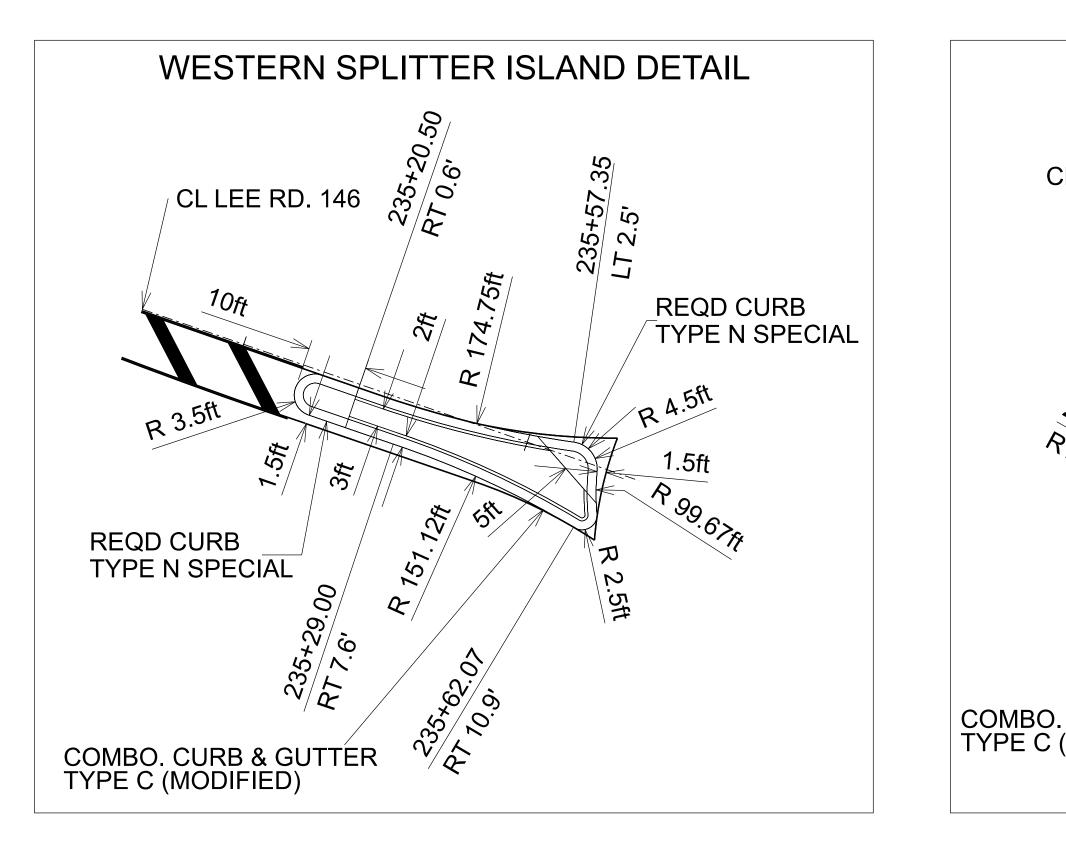


## PAVING DETAIL SHEET PROJECT NO. RALCP 41-146-24 LEE COUNTY

### NORTHERN SPLITTER ISLAND DETAIL CL LEE RD. 54 299+40.3 REQD CURB 1.5ft RT 18.4' TYPE N SPECIAL 4.5ft R 148.83ft 299+07.37 RT7.9, R 470.1ft St **REQD CURB TYPE N SPECIAL** 299+02.31 R 4.5H RT 30.5' S 35 COMBO. CURB & GUTTER C TYPE C (MODIFIED)

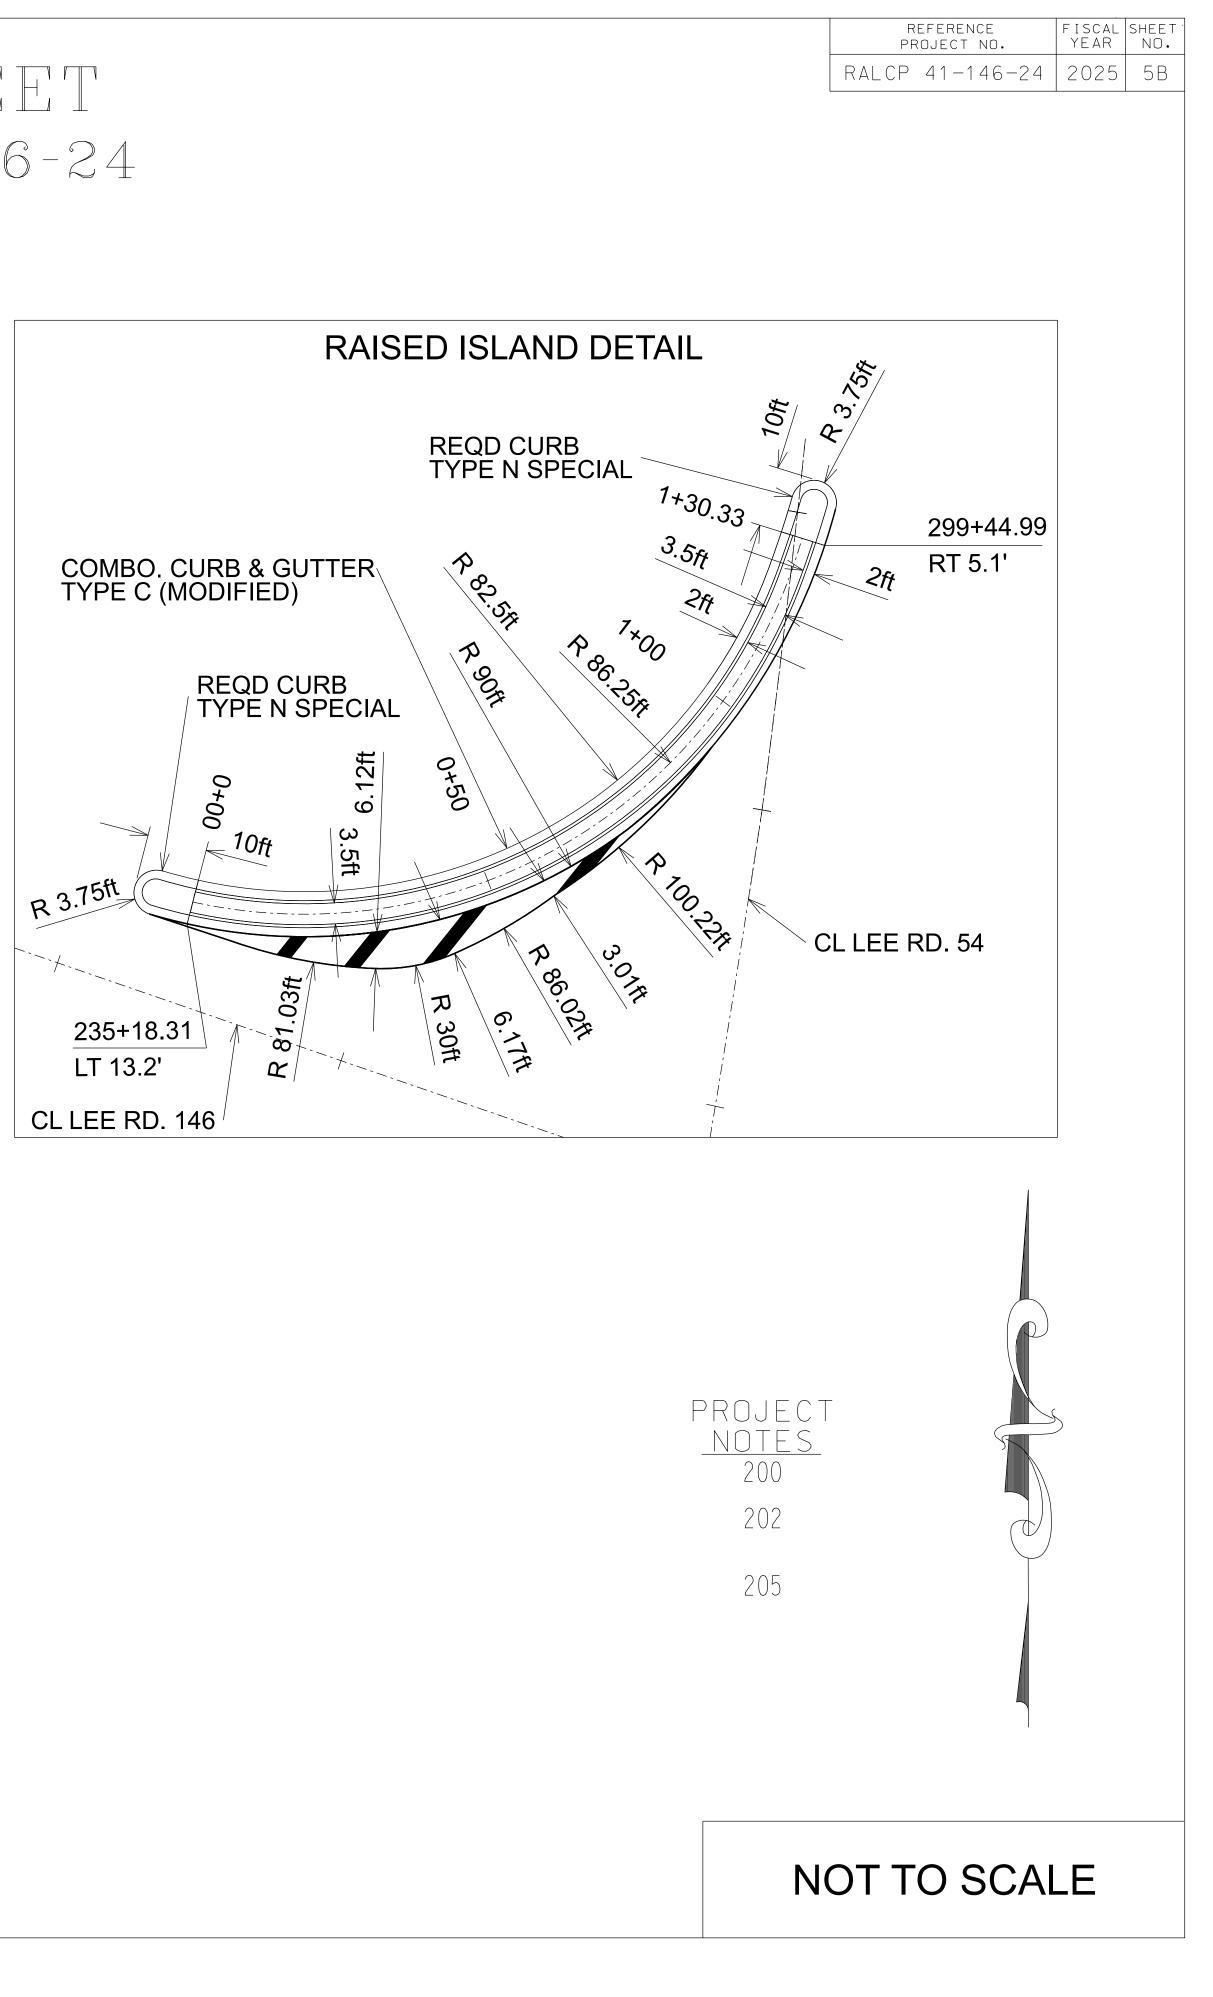


## SIGNAGE AND STRIPING DETAIL SHEET PROJECT NO. RALCP 41-146-24 LEE COUNTY

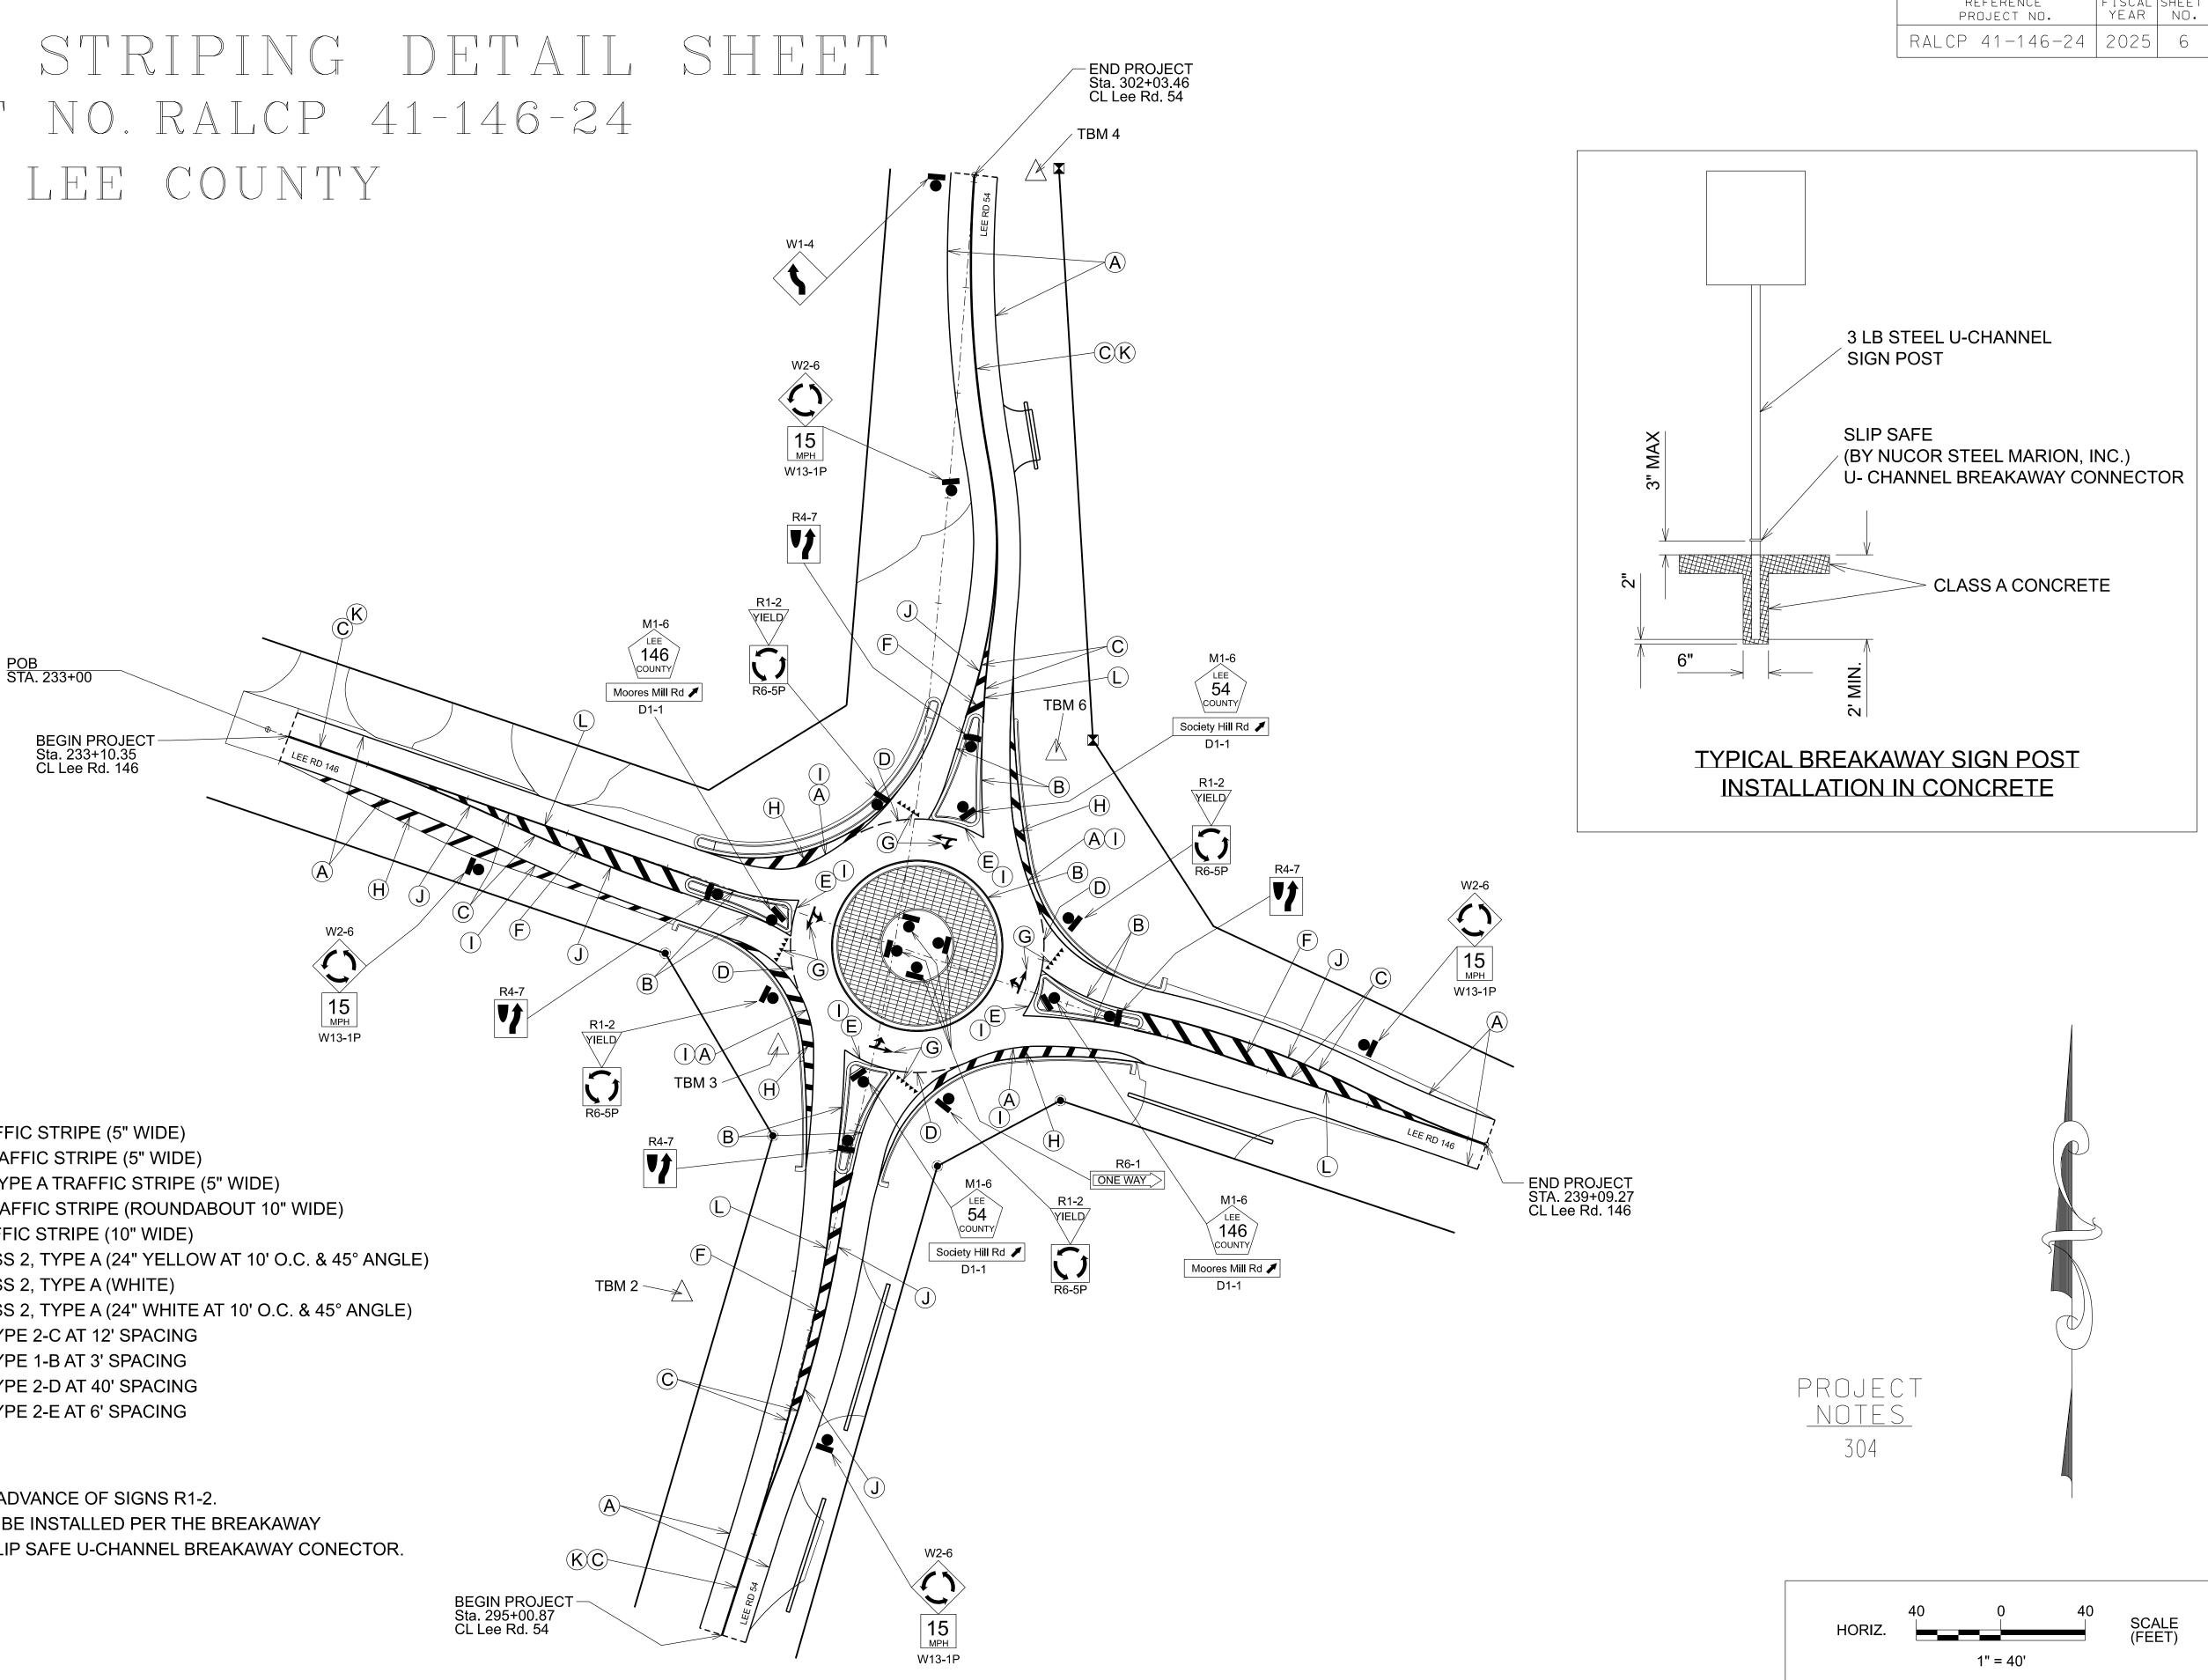

- (A) 701G-253 SOLID WHITE, CLASS 2, TYPE A TRAFFIC STRIPE (5" WIDE)
- (B) 701G-265 SOLID YELLOW, CLASS 2, TYPE A TRAFFIC STRIPE (5" WIDE)
- (C) 701G-265 DOUBLE SOLID YELLOW, CLASS 2, TYPE A TRAFFIC STRIPE (5" WIDE)
- (D) 701B-065 DOTTED WHITE, CLASS 2, TYPE A TRAFFIC STRIPE (ROUNDABOUT 10" WIDE)
- (E) 701A-270 SOLID WHITE, CLASS 2, TYPE A TRAFFIC STRIPE (10" WIDE)
- (F) 703A-002 TRAFFIC CONTROL MARKINGS, CLASS 2, TYPE A (24" YELLOW AT 10' O.C. & 45° ANGLE)
- (G) 703A-002 TRAFFIC CONTROL MARKINGS, CLASS 2, TYPE A (WHITE)
- (H) 703A-002 TRAFFIC CONTROL MARKINGS, CLASS 2, TYPE A (24" WHITE AT 10' O.C. & 45° ANGLE)
- (I) 705A-030 PAVEMENT MARKERS, CLASS A-H, TYPE 2-C AT 12' SPACING
- (J) 705A-032 PAVEMENT MARKERS, CLASS A-H, TYPE 1-B AT 3' SPACING
- (K) 705A-037 PAVEMENT MARKERS, CLASS A-H, TYPE 2-D AT 40' SPACING
- (L) 705A-038 PAVEMENT MARKERS, CLASS A-H, TYPE 2-E AT 6' SPACING

NOTE:

- PLACE SIGNS W2-6 APPROXIMATELY 155 FEET IN ADVANCE OF SIGNS R1-2.
- ALL SIGN POST INSTALLED ON CONCRETE SHALL BE INSTALLED PER THE BREAKAWAY
- SIGN POST INSTALLATION DETAIL UTILIZING THE SLIP SAFE U-CHANNEL BREAKAWAY CONECTOR.

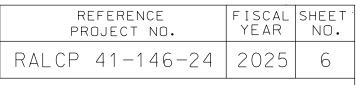


## UNDERGROUND UTILITIES SHEET PROJECT NO. RALCP 41-146-24 LEE COUNTY

### Legend

— FO —— — UGT —  $\bigcirc$ (X)××√ ∽

WATER FIBER OPTIC UNDERGROUND TELEPHONE UTILITY POLE WATER VALVE **FIRE HYDRANT** 

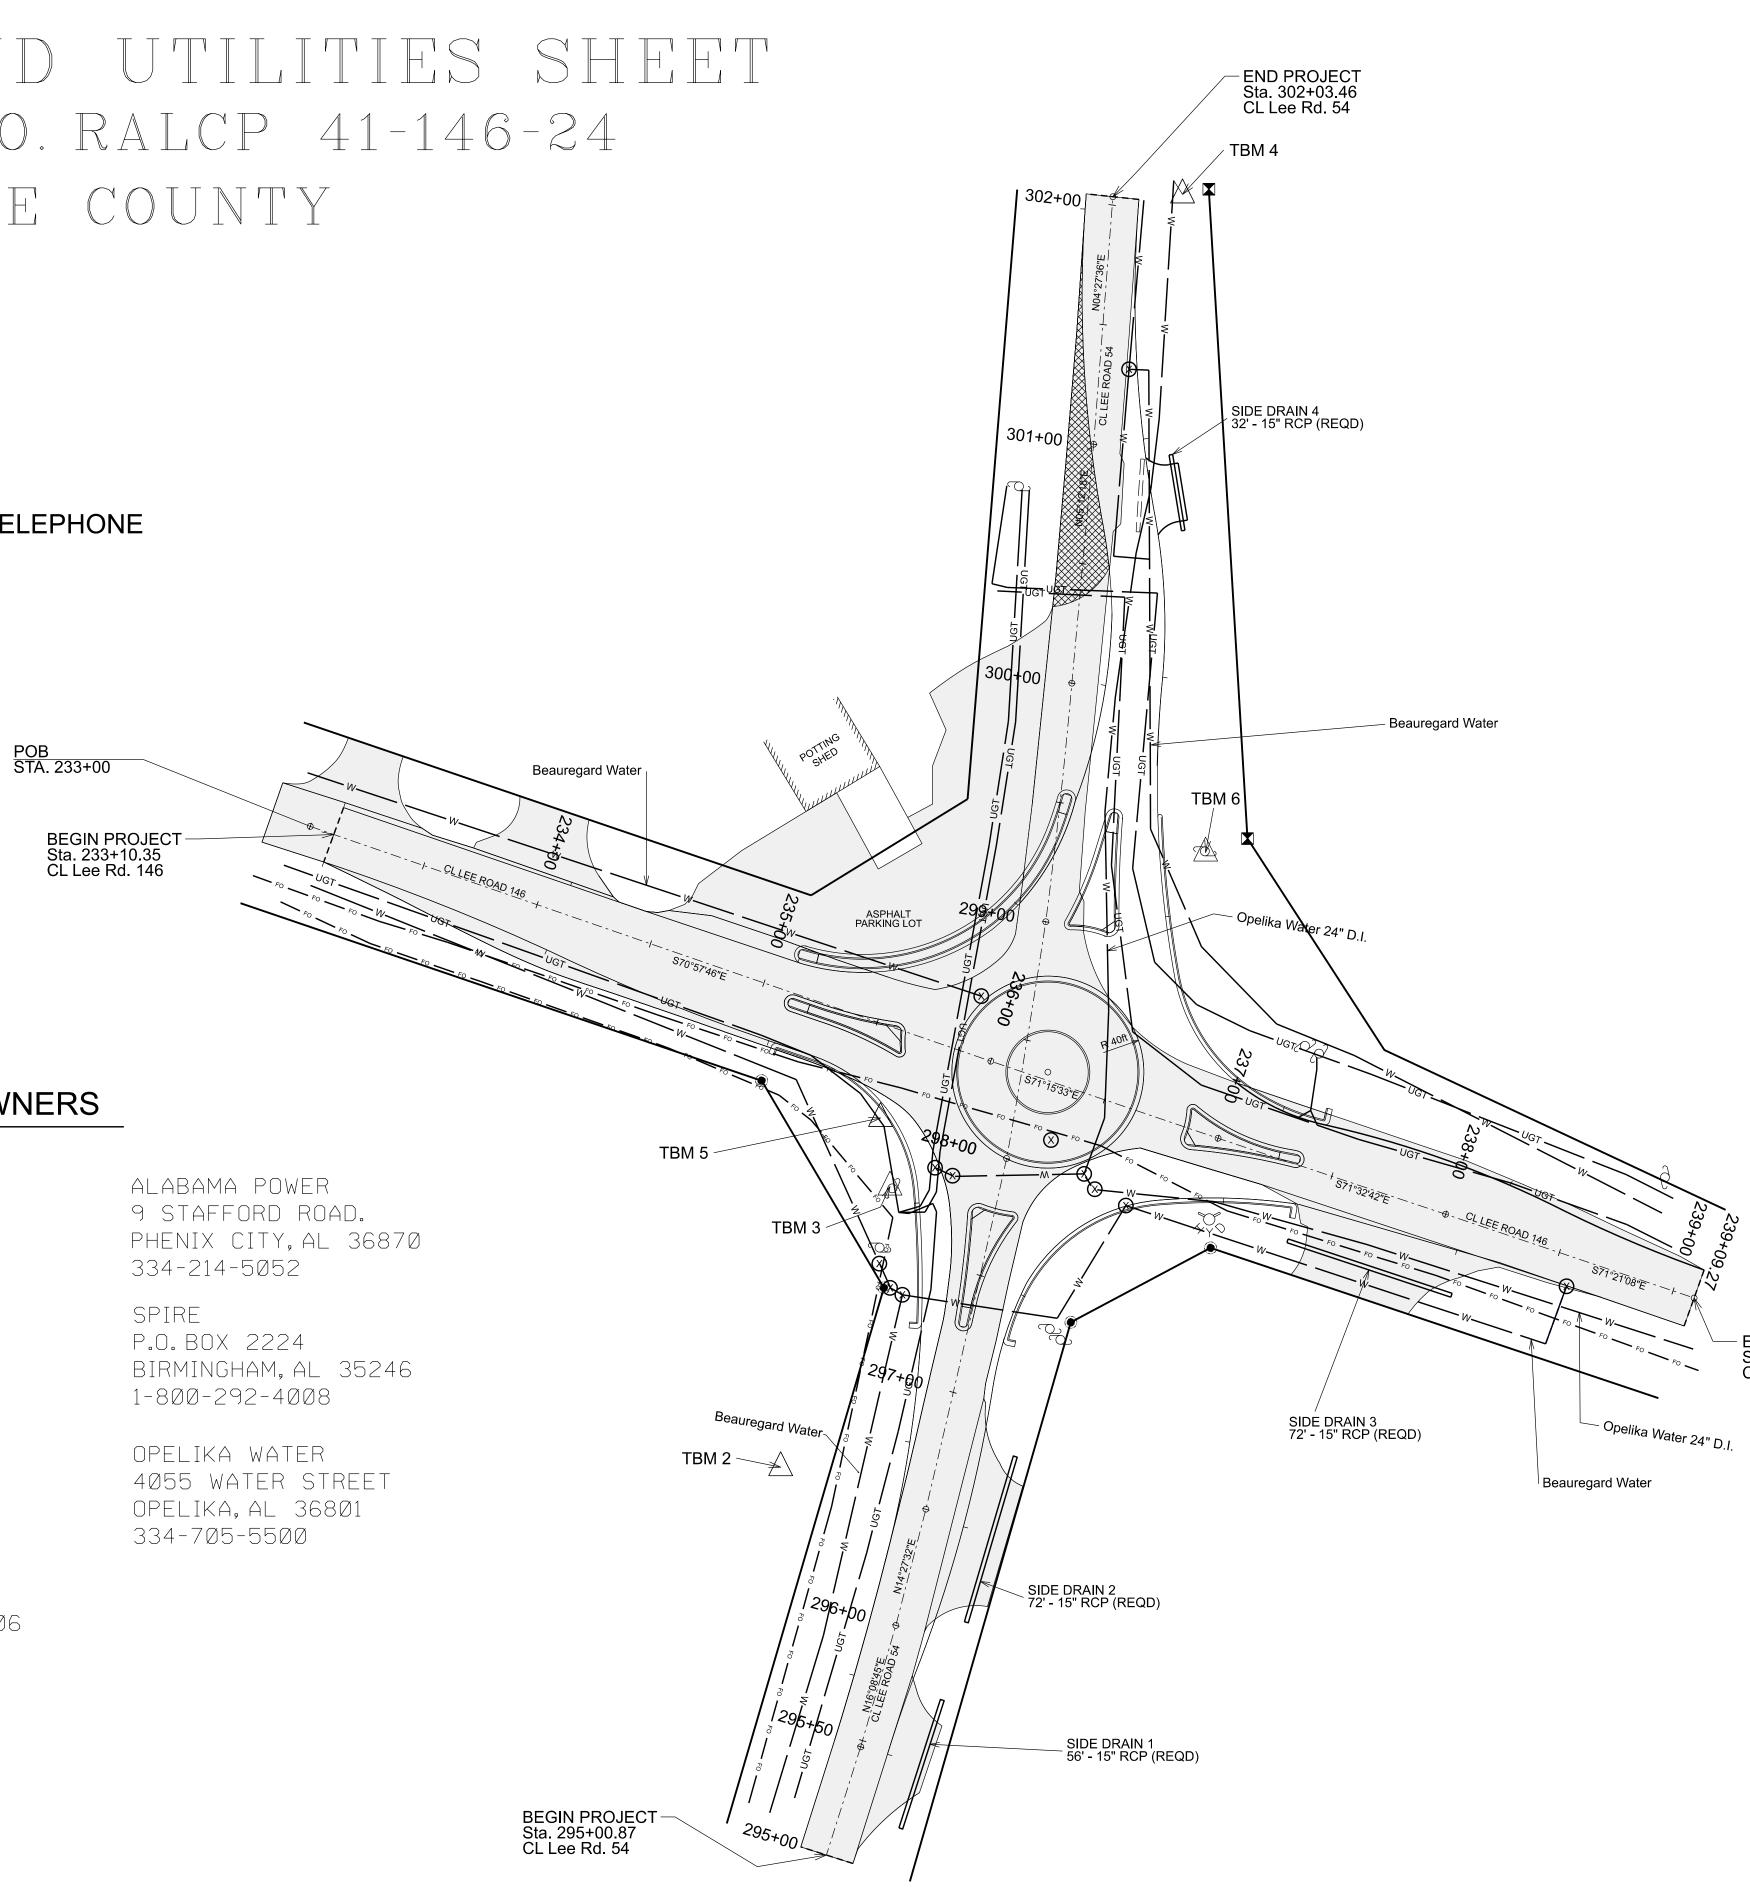

### UTILITY OWNERS

SPECTRUM 2740 ENTERPRISE DRIVE OPELIKA, AL 368Ø1 888-406-7063

AT&T 1801 AIRPORT ROAD OPELIKA, AL 368Ø1 334-741-7856

BEAUREGARD WATER AUTHORITY 7430 AL HWY 51 OPELIKA,AL 368Ø4 334-749-4900

ZAYO 2030 POWERS FERRY RD, SUITE 306 ATLANTA, GA 30339 866-364-6Ø33

PROJECT A CP 41-176-24 2025 7 EXISTING ASPHALT SERVOYE EXISTING ASPHALT SERVOYE PROJECT NO ES 303 807 802 PROJECT 100 ES 100 ES		I						I
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					1" = 40'		(FE	<b>⊢</b> ⊺)

# TRAPROJ

### SEQUENCE OF CONSTRUCTION

### PHASE 1 - WIDENING AND DRAINAGE

CONSTRUCT ROAD WIDENING IN THE NORTHEAST, SOUTHEAST, AND SOUTHWEST QUADRANT OF THE INTERSECTION. CONSTRUCT WIDENING THROUGH THE LOWER BINDER LAYER AND PLACE 3 FOOT CRUSHER RUN SHOULDER FLUSH WITH THE WIDENING.

INSTALL ALL REQUIRED SIDE DRAIN PIPES AND CONSTRUCT STORMWATER DITCHES. PLACE BMP DEVICES AS DIRECTED BY THE ENGINEER.

FLUSH ASPHALT DRIVEWAYS IN WIDENED AREAS WITH ASPHALT AS NECESSARY.

### **PHASE 2A - CENTRAL ISLAND CONSTRUCTION**

RELOCATE ALL APPLICABLE TRAFFIC CONTROL DEVICES. INSTALL ALL REQUIRED CHANNELIZING DRUMS NECESSARY TO CONSTRUCT THE CENTRAL ISLAND, AND INSTALL ALL REQUIRED CHANNELIZING DRUMS AND CONES TO ESTABLISH THE TEMPORARY SPLITTER ISLANDS AS SHOWN.

REMOVE ALL NON-APPLICABLE STRIPING AND MARKINGS THAT ARE OUTSIDE OF THE CENTRAL ISLAND. PLACE TEMPORARY STRIPING AROUND SPLITTER ISLANDS, AND PLACE TEMPORARY

EDGE LINES AND PAVEMENT ARROWS AS SHOWN.

### **PHASE 2B - CENTRAL ISLAND CONSTRUCTION**

ONCE ALL TEMPORARY STRIPING, DRUMS, AND CONES HAVE BEEN PLACED, INSTALL R1-2, AND R6-5P SIGNS, AND CONSTRUCT CENTRAL ISLAND.

### PHASE 3 - SPLITTER ISLAND CONSTRUCTION

RELOCATE ALL APPLICABLE TRAFFIC CONTROL DEVICES.

CONSTRUCT WEST, SOUTH, AND EAST SPLITTER ISLAND.

REMOVE ALL NON-APPLICABLE STRIPING AND MARKINGS.

PLACE TEMPORARY STRIPING ON NEWLY CONSTRUCTED NORTHERN PORTION OF CR-54, RELOCATE ALL APPLICABLE TRAFFIC CONTROL DEVICES AND SHIFT TRAFFIC ONTO NORTHERN PORTION OF CR-54 AS SHOWN.

CONSTRUCT NORTHERN SPLITTER ISLAND.

### PHASE 4 - CONSTRUCT PERIMETER CURBING AND DEMO, ASPHALT

RELOCATE ALL APPLICABLE TRAFFIC CONTROL DEVICES.

REMOVE NON-APPLICABLE STRIPING.

MOVE ALL TRAFFIC ONTO NEWLY CONSTRUCTED PORTION OF CR-54.

CONSTRUCT PERIMETER CURB AND GUTTER, AND DEMO. EXISTING ASPHALT AS SHOWN.

### PHASE 5 - PLACE LEVELING AND WEARING SURFACE ASPHALT


RELOCATE ALL APPLICABLE TRAFFIC CONTROL DEVICES. PLACE LEVELING AND WEARING SURFACE ASPHALT. FLUSH SHOULDERS WITH CRUSHER RUN.

### PHASE 6 - PERMANENT STRIPING AND SIGNAGE


PLACE PERMANENT SIGNAGE AND PERMANENT STRIPING. STABILIZE ALL DISTURBED AREAS. REMOVE CONSTRUCTION TRAFFIC CONTOL DEVICES.

						REFERENCE Project no.	FISCAL SI YEAR
FFIC C	CONTROL PLA					RALCP 41-146	-24 2025
ECT NO.	RALCP 41-146-	-24					
	COUNTY						
	REQUIRED	CONSTRU	CTION	SIGNS			
	ITEM NO	.740B-000	) (SQ.	[ ]			
SIGNS	DESCRIPTION	NO. REQ'D	SQ. FT.	TOTAL SQ.FT.	DRAWING NO.	REMARKS	
G20-1 G20-2	ROAD WORK AHEAD END ROAD WORK	4	8	<u> </u>	IHS-710-12		
W20-1 (1500)	ROAD WORK 1500 FT	4	16	64	HS-710-21 HS-710-23		
W20-1 (1000) W20-1 (500)	ROAD WORK 1000 FT ROAD WORK 500 FT	4	16	64			
W20-4	ONE LANE ROAD AHEAD	4	16	64	SHS-10 SHS-29		
W20-7	FLAGGER (SYMBOL)	6	16	96	SHS-30 SHS-31		
	MUENI MODIZEDO ADE DDECENI						
R16-3	WHEN WORKERS ARE PRESEN Speeding fines doubled	1, 4	20	80	SEE TCP		
R16-3a	END DOUBLE FINES	4	16	64	DESCRIPTION		
		SUBT	ot al	560.0			
		TOT	TAL	560			

	REQUIRED TRAFFIC CONTROL	DEVIC	ES	
ITEM NUMBER	DESCRIPTION	QTY (EACH)	DRAWING NO.	REMARKS
	CHANNELIZING DRUMS CONES (36 INCHES HIGH)	150 200	TCD-100	
742A-001	PORTABLE CHANGEABLE MESSAGE SIGN, TYPE 2	4	PCMS-710 (SHEETS 1-3)	

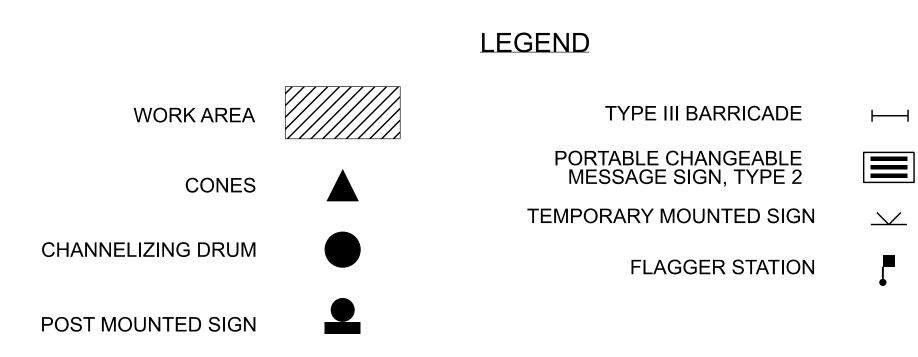

## TRAFFIC CONTROL PLAN, PHASE 1 PROJECT NO. RALCP 41-146-24 LEE COUNTY

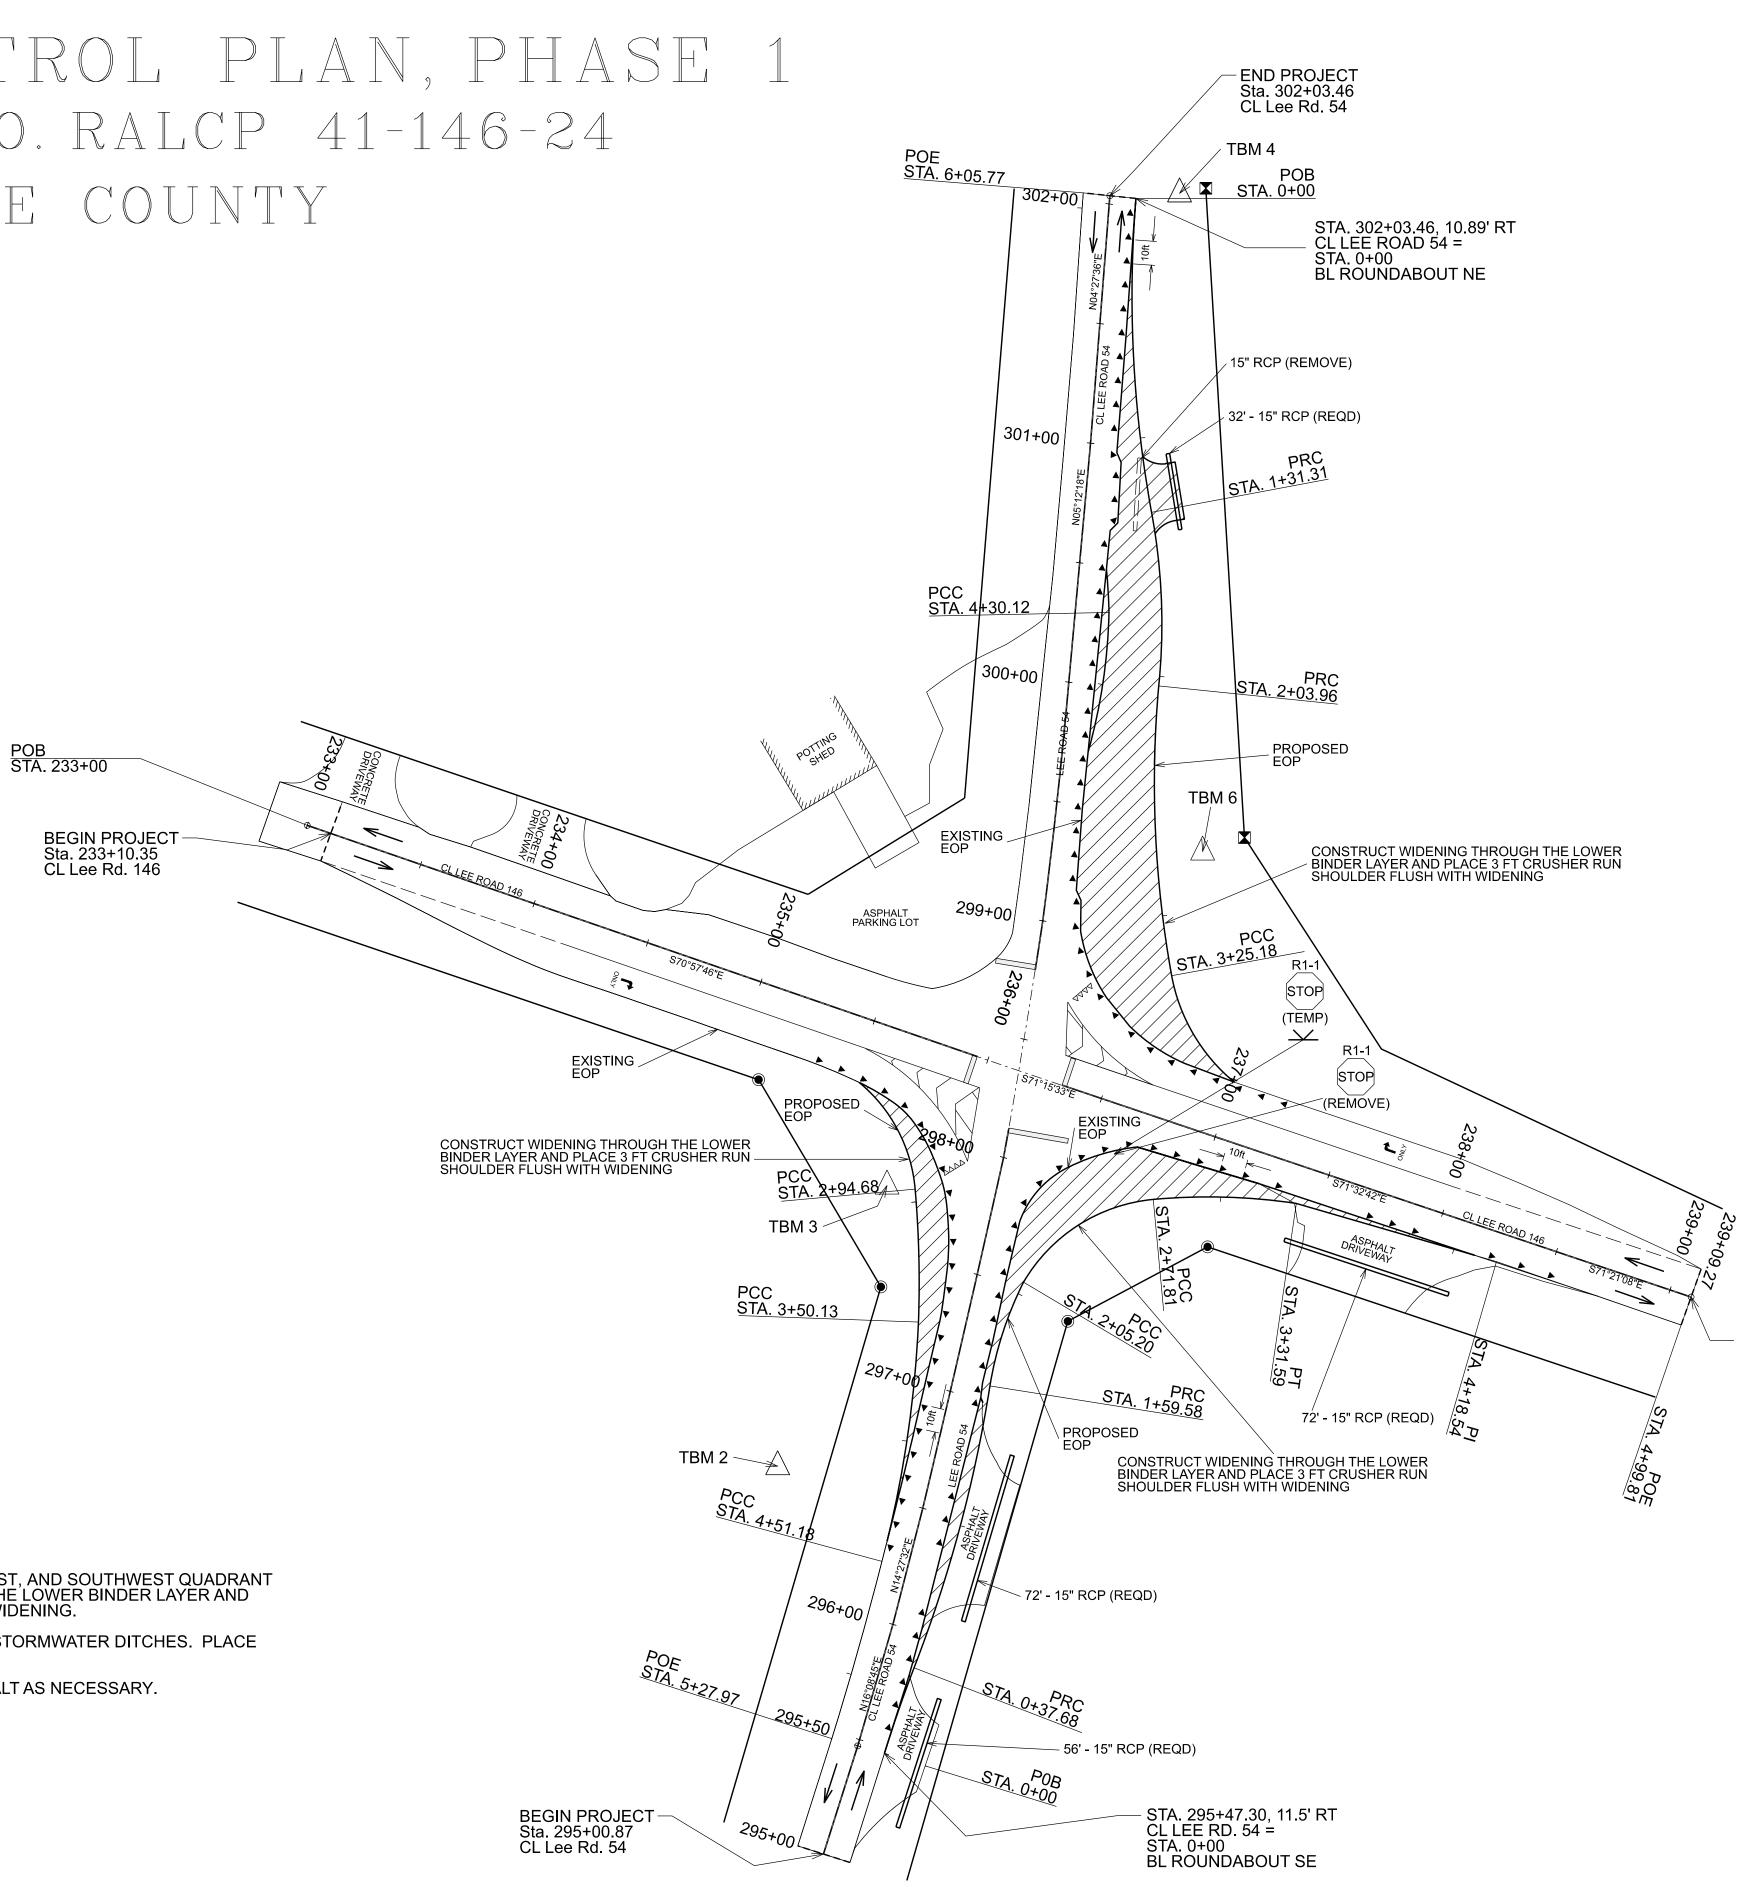

### SEQUENCE OF CONSTRUCTION

PHASE 1 - WIDENING AND DRAINAGE

CONSTRUCT ROAD WIDENING IN THE NORTHEAST, SOUTHEAST, AND SOUTHWEST QUADRANT OF THE INTERSECTION. CONSTRUCT WIDENING THROUGH THE LOWER BINDER LAYER AND PLACE 3 FOOT CRUSHER RUN SHOULDER FLUSH WITH THE WIDENING.


INSTALL ALL REQUIRED SIDE DRAIN PIPES AND CONSTRUCT STORMWATER DITCHES. PLACE BMP DEVICES AS DIRECTED BY THE ENGINEER.

FLUSH ASPHALT DRIVEWAYS IN WIDENED AREAS WITH ASPHALT AS NECESSARY.

REFERENCE	FISCAL	SHEET '
Project no.	YEAR	NO.
RALCP 41-146-24	2025	8 A


### LEGEND

WORK AREA	
CONES	
CHANNELIZING DRUM	
POST MOUNTED SIGN	
TYPE III BARRICADE	н
PORTABLE CHANGEABLE MESSAGE SIGN, TYPE 2	
TEMPORARY MOUNTED SIGN	$\checkmark$
FLAGGER STATION	

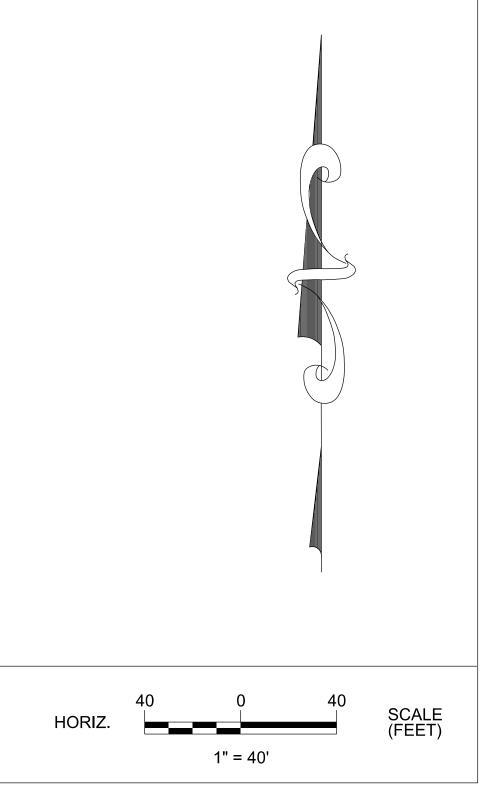

- END PROJECT STA. 239+09.27 CL Lee Rd. 146

## TRAFFIC CONTROL PLAN, PHASE 2A PROJECT NO. RALCP 41-146-24 LEE COUNTY

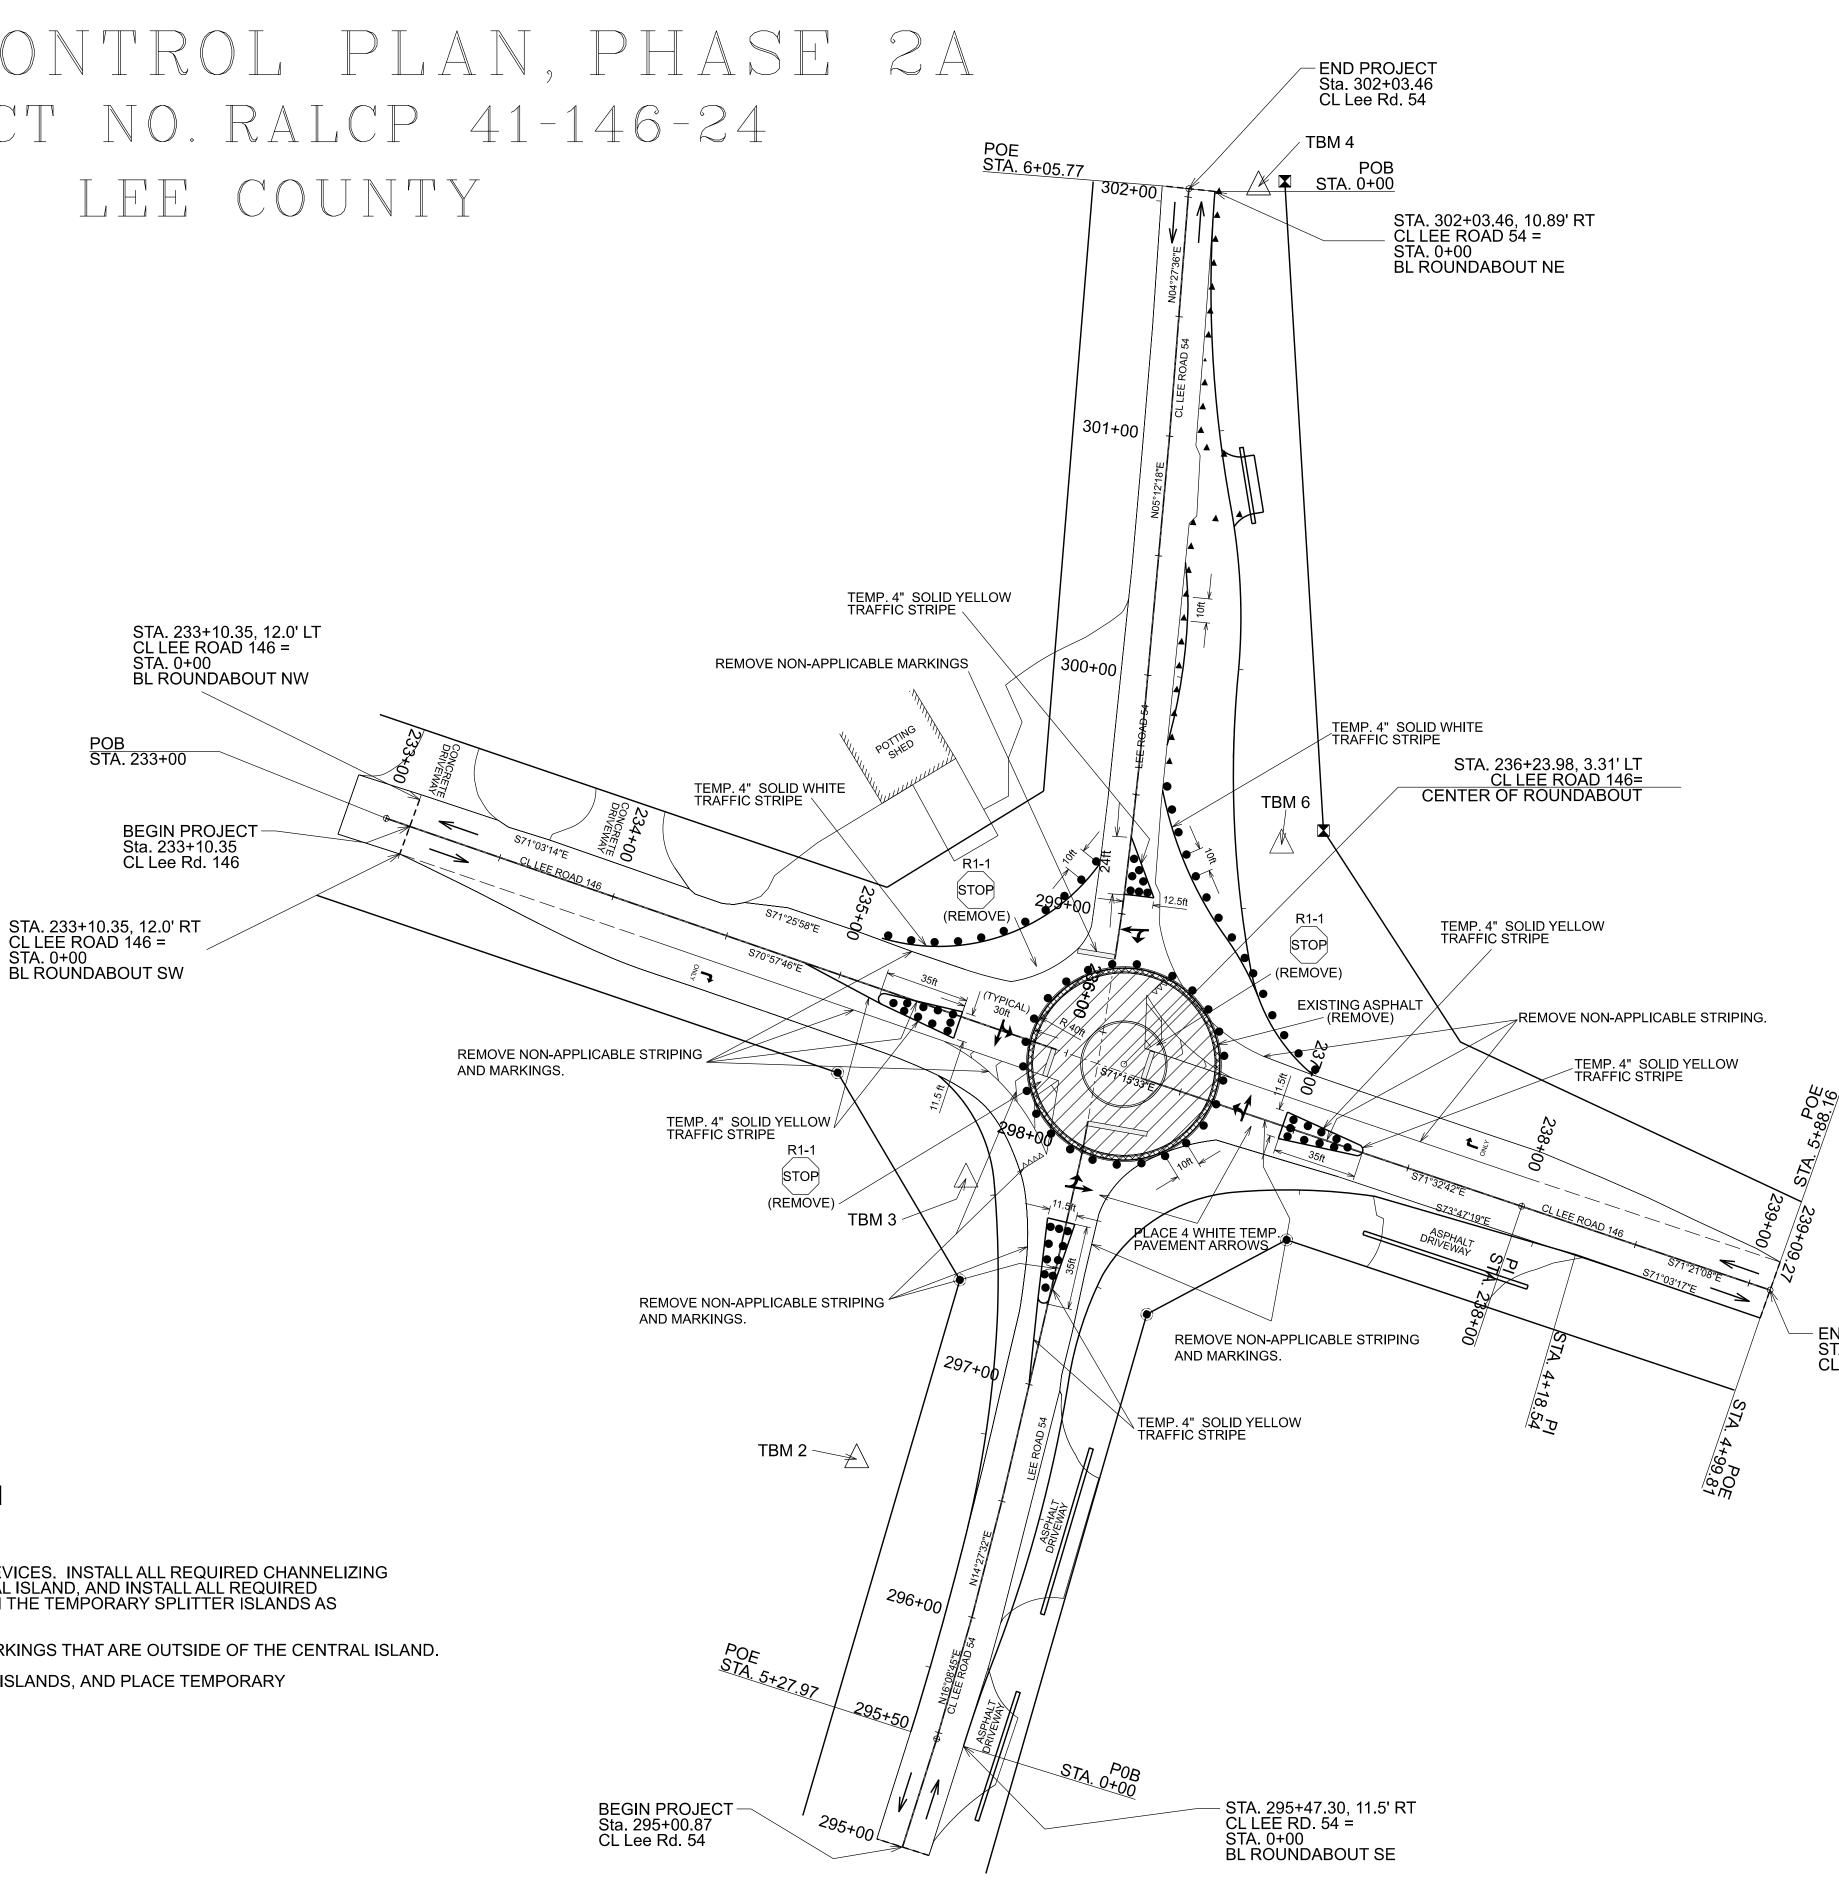

### SEQUENCE OF CONSTRUCTION


### **PHASE 2 - CENTRAL ISLAND CONSTRUCTION**

RELOCATE ALL APPLICABLE TRAFFIC CONTROL DEVICES. INSTALL ALL REQUIRED CHANNELIZING DRUMS NECESSARY TO CONSTRUCT THE CENTRAL ISLAND, AND INSTALL ALL REQUIRED CHANNELIZING DRUMS AND CONES TO ESTABLISH THE TEMPORARY SPLITTER ISLANDS AS SHOWN.

REMOVE ALL NON-APPLICABLE STRIPING AND MARKINGS THAT ARE OUTSIDE OF THE CENTRAL ISLAND. PLACE TEMPORARY STRIPING AROUND SPLITTER ISLANDS, AND PLACE TEMPORARY EDGE LINES AND PAVEMENT ARROWS AS SHOWN.

		0.
	RALCP 41-146-24 2025 8	B
	LEGEND	
	WORK AREA	
	CONES	
	CHANNELIZING DRUM	
	POST MOUNTED SIGN	
	PORTABLE CHANGEABLE MESSAGE SIGN, TYPE 2	
	TEMPORARY MOUNTED SIGN	
	FLAGGER STATION	
<i>U</i> (6)		
19 19 19		
END PROJECT STA. 239+09.27 CL Lee Rd. 146		
	40     0     40       HORIZ.     SCALE       (FEET)	
	1" = 40'	

## TRAFFIC CONTROL PLAN, PHASE 2B PROJECT NO. RALCP 41-146-24 LEE COUNTY

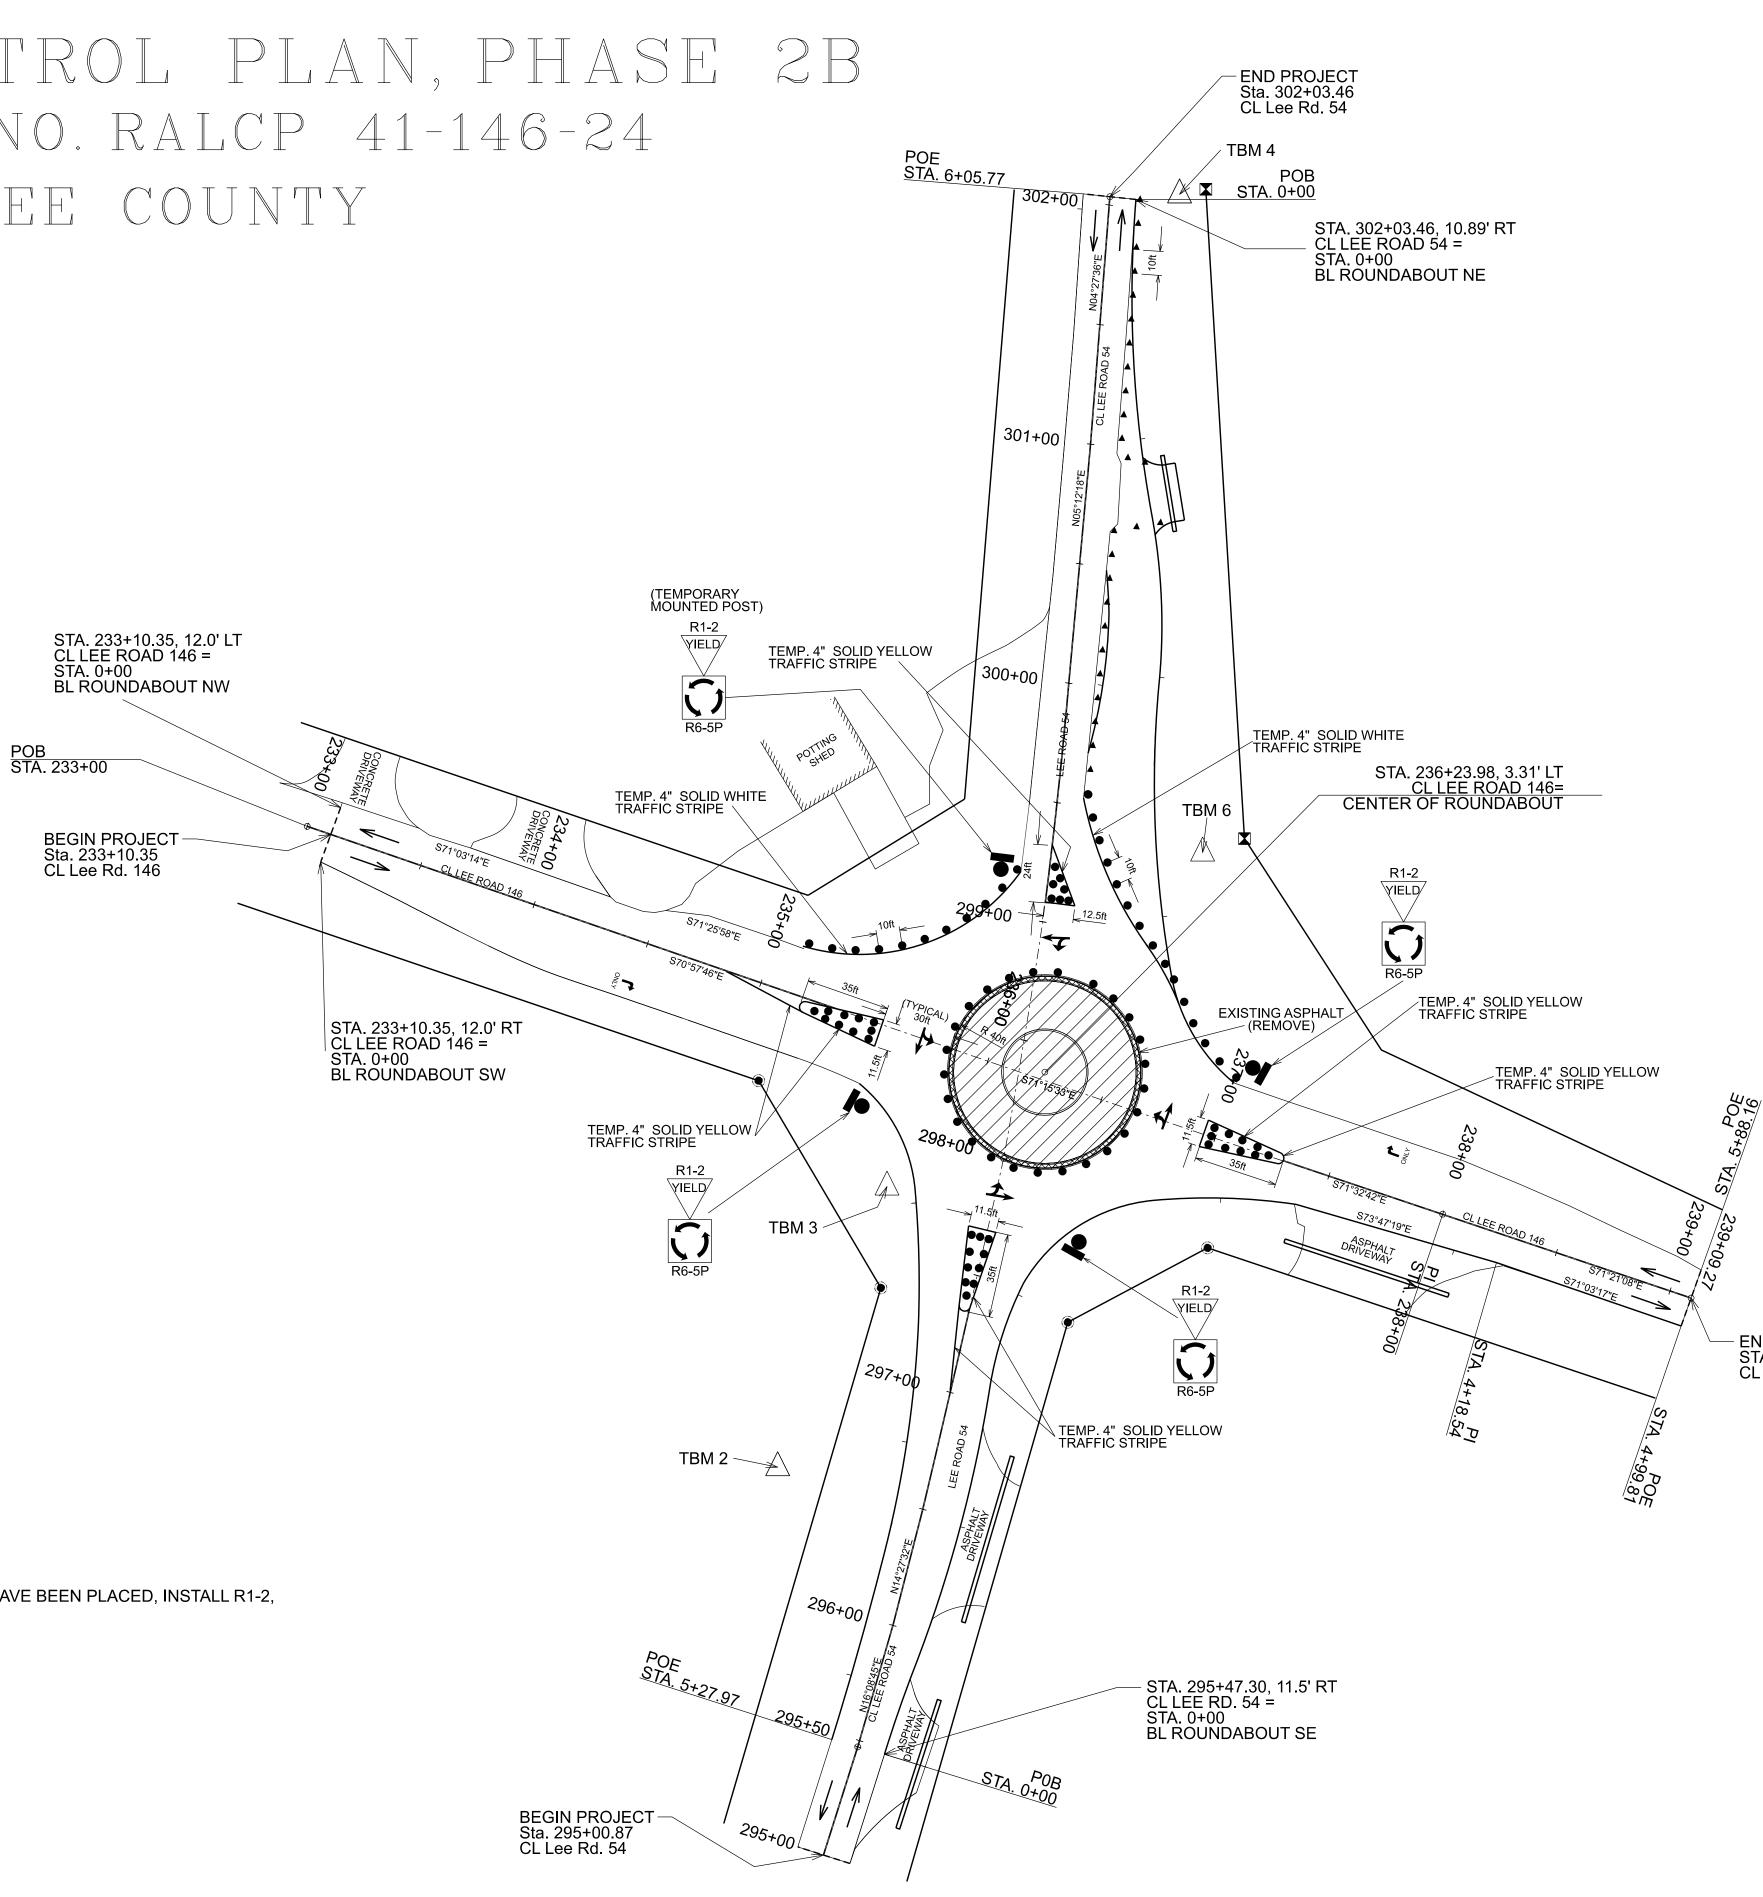


### SEQUENCE OF CONSTRUCTION

**PHASE 2 - CENTRAL ISLAND CONSTRUCTION** 

ONCE ALL TEMPORARY STRIPING, DRUMS, AND CONES HAVE BEEN PLACED, INSTALL R1-2, AND R6-5P SIGNS, AND CONSTRUCT CENTRAL ISLAND.

	REFERENCE PROJECT NO. FISCAL SHEET YEAR NO. RALCP 41-146-24 2025 8C
	LEGEND
	LEGEND
	WORK AREA
	CONES
	CHANNELIZING DRUM
	POST MOUNTED SIGN
	TYPE III BARRICADE
	PORTABLE CHANGEABLE MESSAGE SIGN, TYPE 2
	TEMPORARY MOUNTED SIGN
	FLAGGER STATION
D/	
ND PROJECT TA. 239+09.27 L Lee Rd. 146	
	HORIZ. 40 0 40 SCALE (FEET) 1" = 40'

## TRAFFIC CONTROL PLAN, PHASE 3 PROJECT NO. RALCP 41-146-24 LEE COUNTY

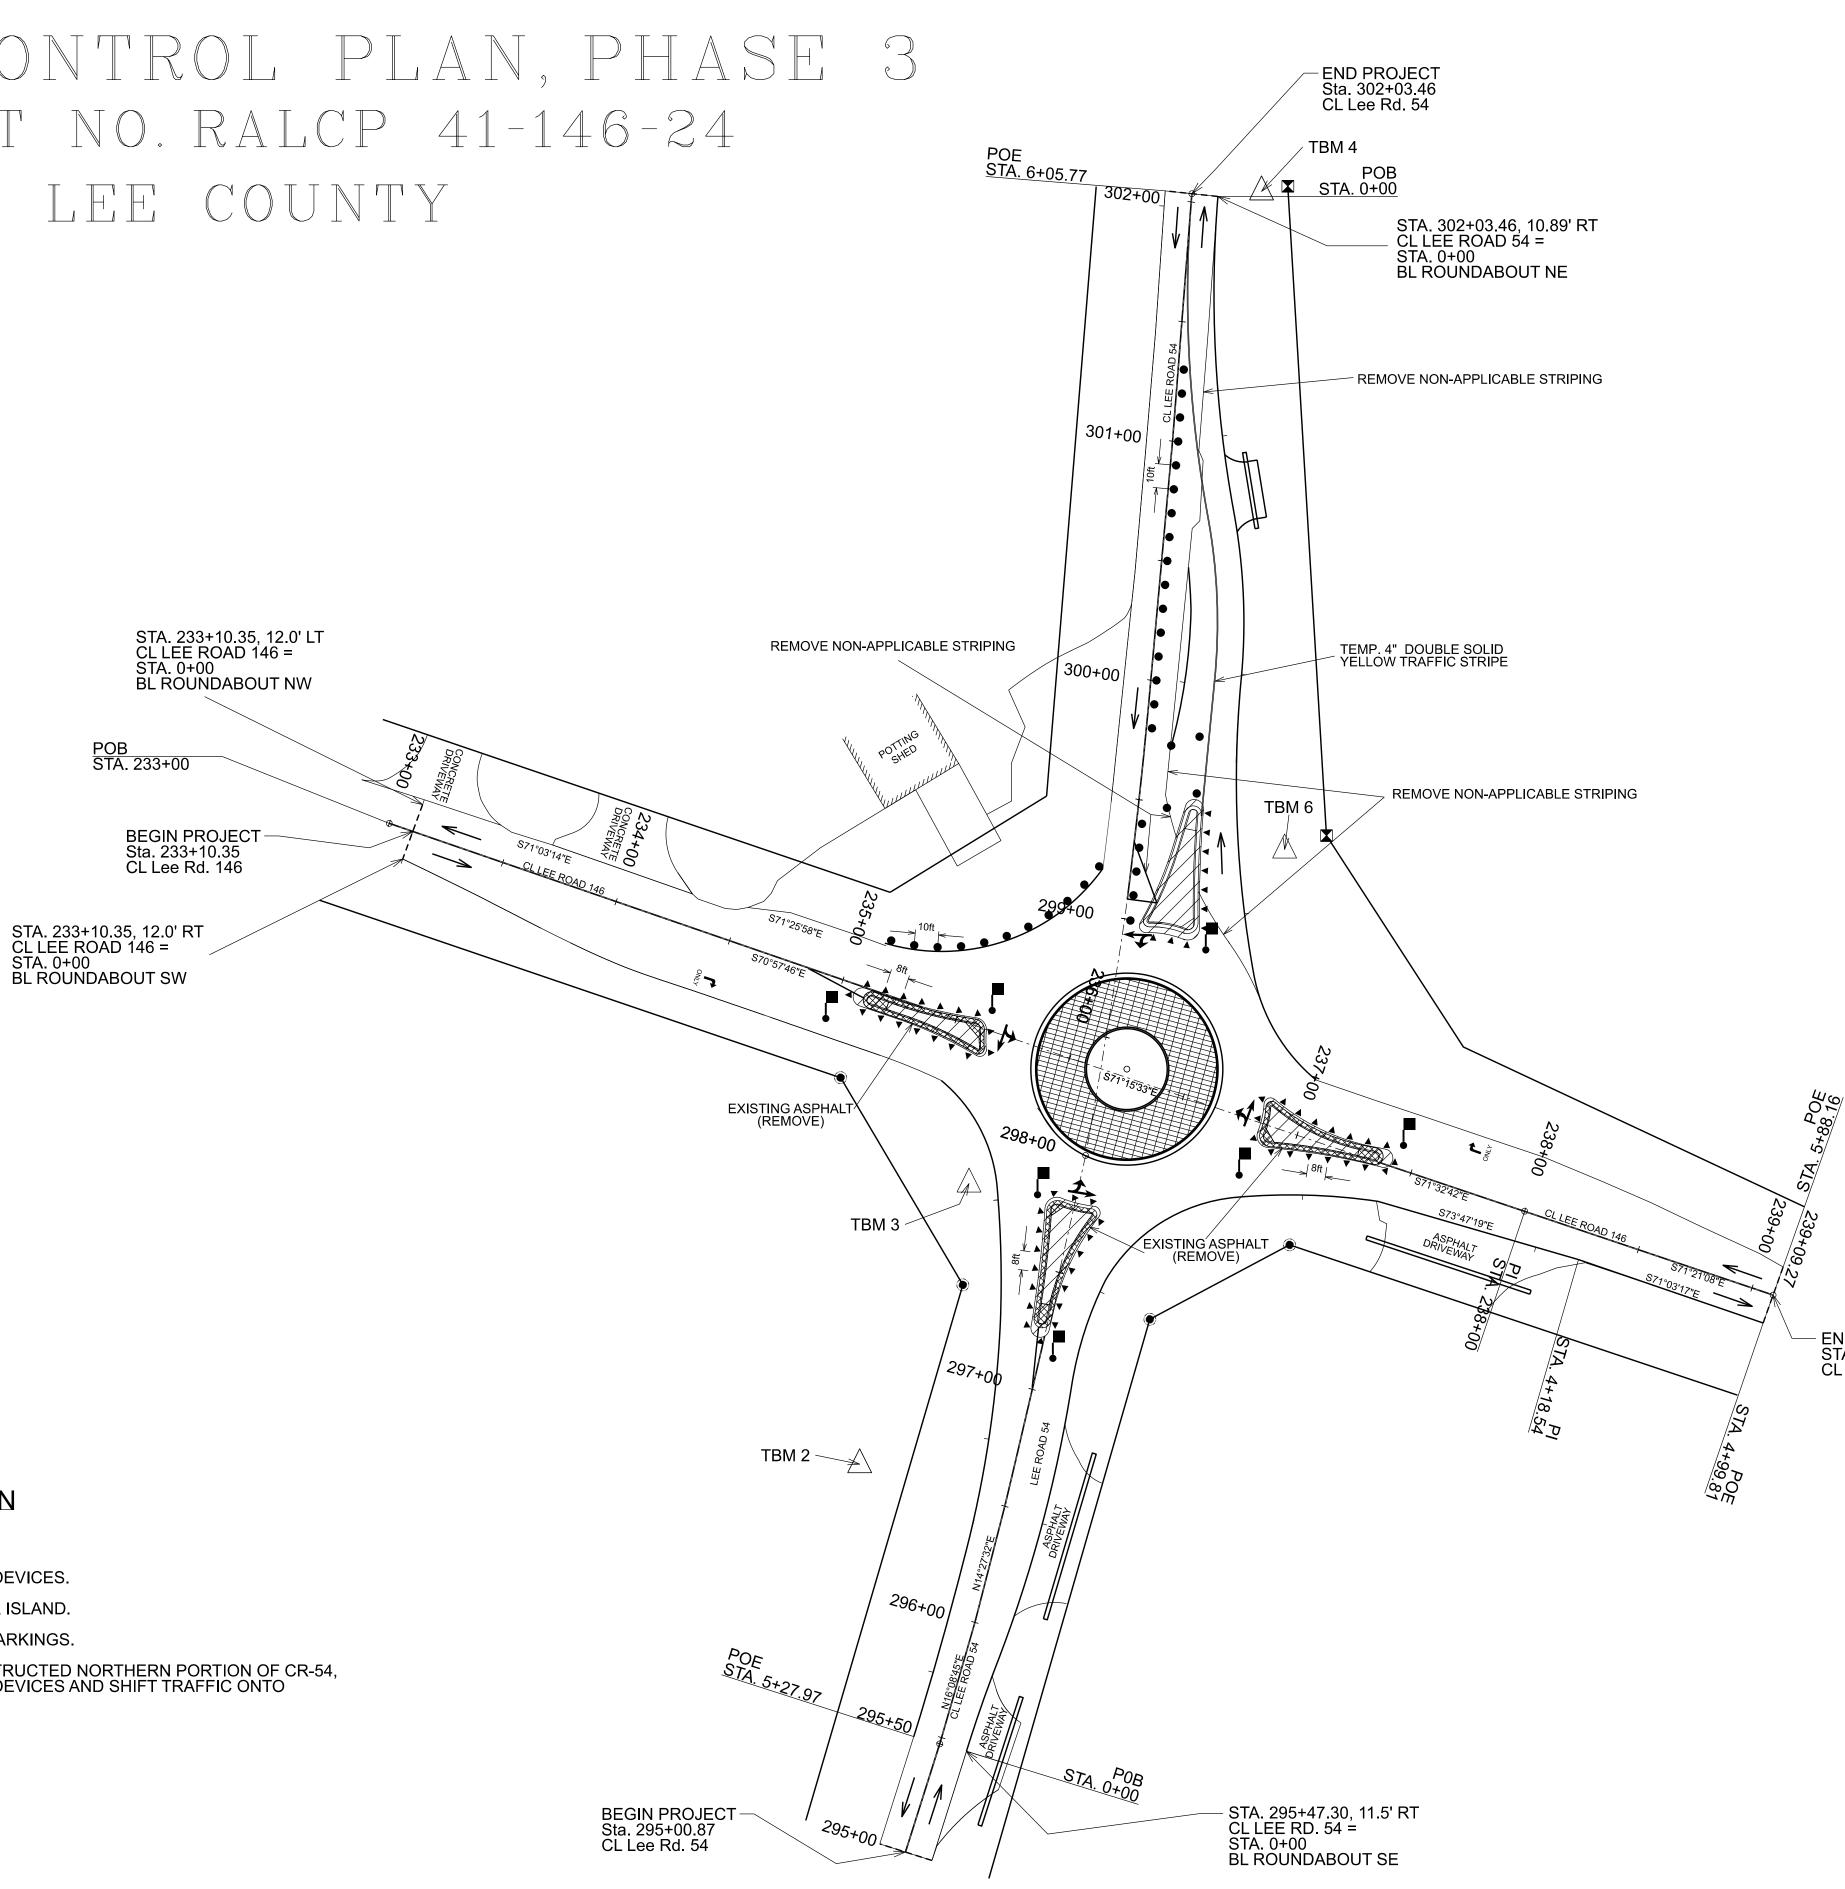

### SEQUENCE OF CONSTRUCTION

**PHASE 3 - SPLITTER ISLAND CONSTRUCTION** 


RELOCATE ALL APPLICABLE TRAFFIC CONTROL DEVICES. CONSTRUCT WEST, SOUTH, AND EAST SPLITTER ISLAND.

REMOVE ALL NON-APPLICABLE STRIPING AND MARKINGS.

PLACE TEMPORARY STRIPING ON NEWLY CONSTRUCTED NORTHERN PORTION OF CR-54, RELOCATE ALL APPLICABLE TRAFFIC CONTROL DEVICES AND SHIFT TRAFFIC ONTO NORTHERN PORTION OF CR-54 AS SHOWN. CONSTRUCT NORTHERN SPLITTER ISLAND.

	REFERENCE FISCAL SHEET PROJECT NO. YEAR NO.
	RALCP 41-146-24 2025 8D
	LEGEND
	WORK AREA
	CONES
	CHANNELIZING DRUM
	POST MOUNTED SIGN
	PORTABLE CHANGEABLE MESSAGE SIGN, TYPE 2
	FLAGGER STATION
PROJECT	
) PROJECT 239+09.27 .ee Rd. 146	
	40 0 40
	HORIZ. SCALE (FEET)
	1" = 40'

## TRAFFIC CONTROL PLAN, PHASE 4 PROJECT NO. RALCP 41-146-24 LEE COUNTY

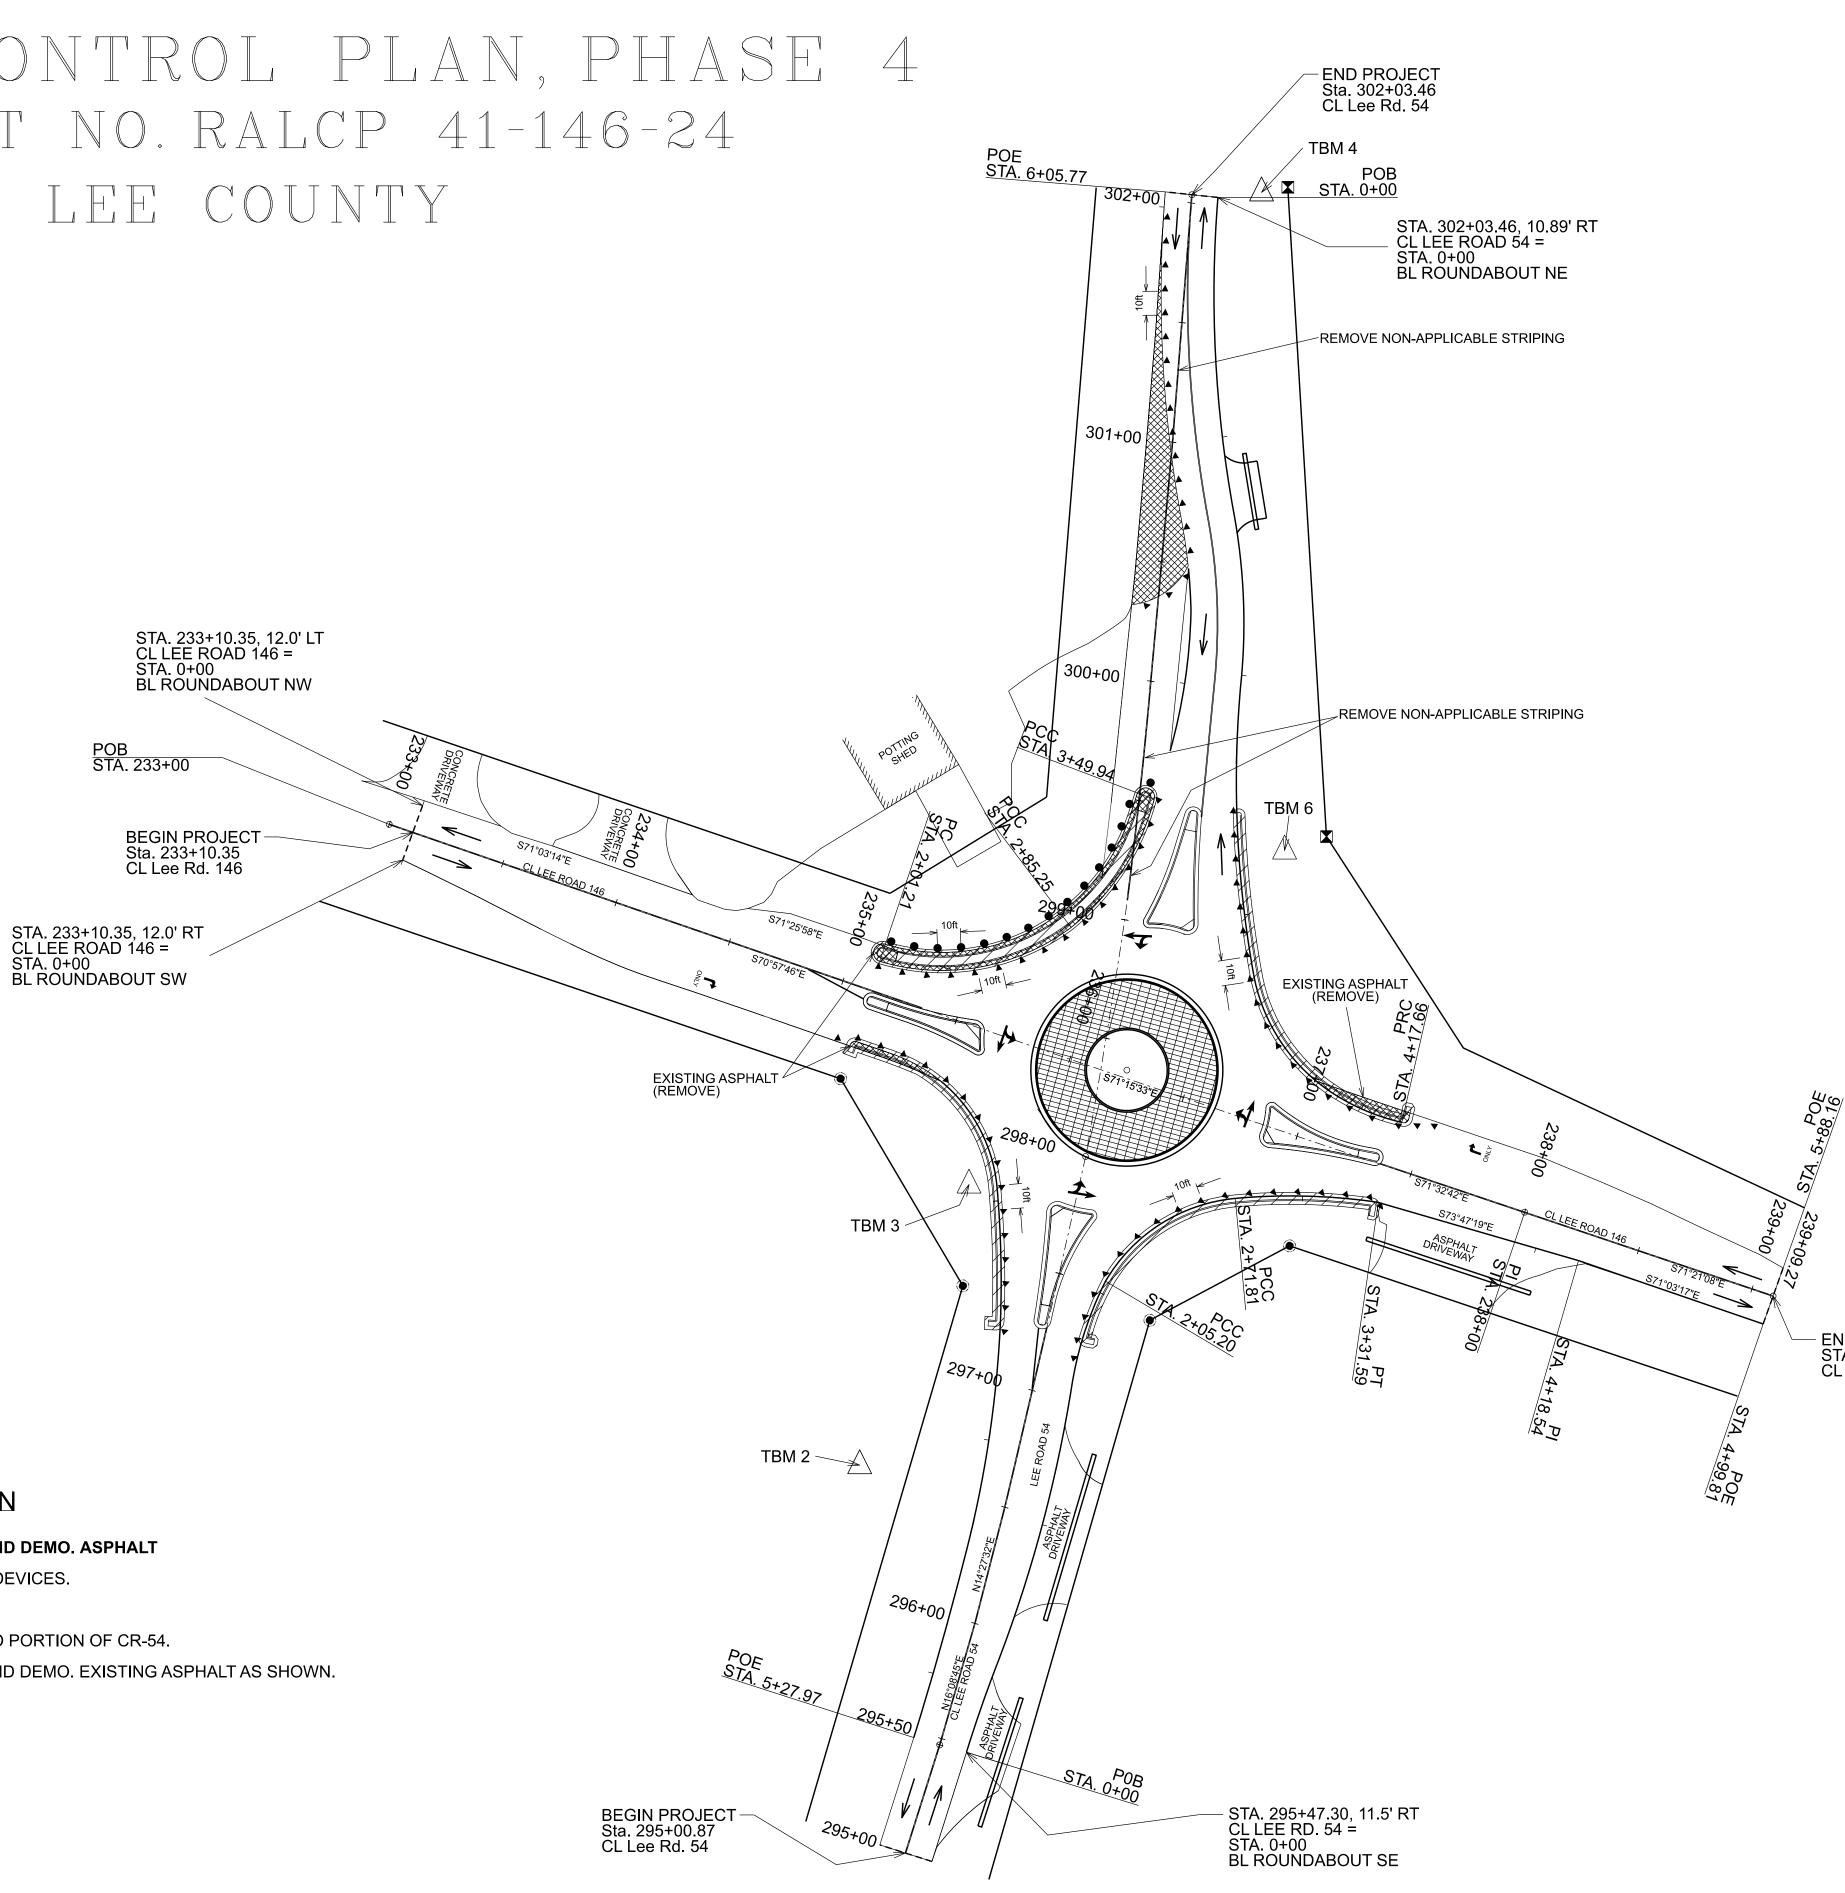

### SEQUENCE OF CONSTRUCTION

PHASE 4 - CONSTRUCT PERIMETER CURBING AND DEMO. ASPHALT RELOCATE ALL APPLICABLE TRAFFIC CONTROL DEVICES. REMOVE NON-APPLICABLE STRIPING. MOVE ALL TRAFFIC ONTO NEWLY CONSTRUCTED PORTION OF CR-54.

CONSTRUCT PERIMETER CURB AND GUTTER, AND DEMO. EXISTING ASPHALT AS SHOWN.

	REFERENCE PROJECT NO. RALCP 41-146-24 2025 8E
	LEGEND
	WORK AREA
	CONES
	CHANNELIZING DRUM
	POST MOUNTED SIGN
	TYPE III BARRICADE
	PORTABLE CHANGEABLE MESSAGE SIGN, TYPE 2
	TEMPORARY MOUNTED SIGN
	FLAGGER STATION
0/	
ND PROJECT TA. 239+09.27 L Lee Rd. 146	
	HORIZ. $\begin{array}{c} 40 & 0 & 40 \\ \hline HORIZ. & \hline \\ 1" = 40' \end{array}$ SCALE (FEET)

- 700 THE TRAFFIC CONTROL PLAN IS DEVELOPED IN CONFORMANCE WITH THE MANUAL ON UNIFORM TRAFFIC CONTROL DEVICES PART 6, 2009 EDITION. THE TRAFFIC CONTROL DEVICES INDICATED REPRESENT CONDITIONS KNOWN DURING PLAN DEVELOPMENT. IN THE EVENT ACTUAL PHYSICAL CONDITIONS WARRANT ADDITIONAL TRAFFIC CONTROL DEVICES, THEY SHALL BE INSTALLED IN CONFORMANCE WITH THE M.U.T.C.D. PART 6 AS DIRECTED BY THE ENGINEER. COST SHALL BE PAID FOR UNDER THE APPROPRIATE PAY ITEM.
- 701 ALL BLACK ON ORANGE CONSTRUCTION SIGNS SHALL BE FABRICATED USING TYPE XI FLUORESCENT ORANGE REFLECTIVE SHEETING MATERIAL FOR THE SIGN BACKGROUND.
- 702 DURING NON-WORKING HOURS NO EQUIPMENT OR MATERIAL SHALL BE PARKED OR STORED CLOSER THAN 30 FEET TO THE EDGE OF ANY ROADWAY CARRYING TRAFFIC. WHEN THIS IS NOT PRACTICAL, IT SHALL BE PLACED IN AN AREA APPROVED BY THE ENGINEER AND DELINEATED BY REFLECTORIZED DRUMS. THIS INCLUDES STORAGE OF TRAFFIC CONTROL DEVICES SUCH AS TRAILER MOUNTED OR OTHER TEMPORARY SIGNS, BARRICADES, DRUMS, ETC., WHICH ARE NOT IN USE DURING NON-WORKING HOURS. TO BE FURNISHED BY THE CONTRACTOR WITHOUT COST TO THE ALDOT. (SEE SKETCH ON SHEET )
- 703 WHERE THE LOCATION OF A REQUIRED SIGN FALLS IN A DRIVEWAY, SIDEWALK, BRIDGE, ETC., OR WHERE THE VISIBILITY OF A SIGN IS LIMITED TO THE TRAVELING PUBLIC, THE LOCATION SHALL BE ADJUSTED AS DIRECTED BY THE ENGINEER.
- 704 THE CONTRACTOR IS TO REMOVE, RELOCATE OR COVER DURING CONSTRUCTION AND THEN RESET OR UNCOVER UPON COMPLETION OF A PARTICULAR SECTION ANY CONFLICTING IN-PLACE ROADWAY SIGNS AND DELINEATORS, AS DIRECTED BY THE ENGINEER. SIGNS REQUIRING REMOVAL SHALL BE STOCKPILED AS DIRECTED BY THE ENGINEER AND SHALL BECOME PROPERTY OF THE ALDOT. COST SHALL BE A SUBSIDIARY OBLIGATION OF ITEM 740B.
- 705 DURING ALL PHASES OF WORK, NON-APPLICABLE PAVEMENT STRIPING OR MARKINGS SHALL BE REMOVED AND APPROPRIATE PAVEMENT STRIPING OR MARKINGS SHALL BE PLACED AS EXPEDITIOUSLY AS PRACTICAL, BUT IN ALL CASES, SHALL BE IN PLACE BY NIGHTFALL ON ANY ROADWAY CARRYING TRAFFIC, EXCEPT ON SHORT TERM OPERATIONS WHERE IT IS DETERMINED BY THE ENGINEER, THAT SUCH REMOVAL AND REPLACEMENT IS MORE HAZARDOUS THAN LEAVING EXISTING MARKINGS IN PLACE. COST OF ANY REMOVAL SHALL BE PAID FOR UNDER ITEM 701D OR AS A SUBSIDIARY **OBLIGATION OF ITEM 701C.**
- 706 OMITTED
- 707 THE CONTRACTOR SHALL PLACE ALL ADVANCE WARNING SIGNS BEFORE PROCEEDING WITH HIS WORK. SIGNS SHALL BE PLACED IN ORDER, IN THE DIRECTION OF TRAFFIC AND REMOVED IN REVERSE ORDER.
- 708 ALL VEHICLES, EQUIPMENT, PERSONNEL (EXCEPT FLAGGERS), AND THEIR ACTIVITIES, ARE RESTRICTED AT ALL TIMES TO ONE SIDE OF THE PAVEMENT UNLESS OTHERWISE AUTHORIZED BY THE ENGINEER.
- 709 THE CONTRACTOR SHALL MAINTAIN AT LEAST ONE ACCESS TO BUSINESSES AND RESIDENCES DURING ALL PHASES OF CONSTRUCTION.
- 710 CONSTRUCTION SIGNS MOUNTED ON TEMPORARY SUPPORTS SHALL BE MOUNTED AT A MINIMUM HEIGHT OF 5 FEET
- 711 FLAGGERS SHALL BE PROPERLY ATTIRED, EQUIPPED WITH STAFF MOUNTED STOP/SLOW PADDLES IN SIGHT OF EACH OTHER, OR HAVE DIRECT COMMUNICATION AT ALL TIMES. FLAGGER STATION LOCATION MAY BE VARIED FROM THOSE SHOWN BASED ON ROADWAY ALIGNMENT AND CONDITIONS AT THE TIME OF THE LANE CLOSURE.
- 712 FLAGGERS ARE TO BE USED WHEN DIRECTED BY THE ENGINEER. SIGNS SHALL BE PLACED AT THE APPROPRIATE TIME, AND SHALL BE COVERED OR REMOVED WHEN FLAGGERS ARE NOT ON DUTY AND DURING NON-WORKING HOURS.
- 713 FOR MOVING OPERATIONS, THE TRAFFIC CONES MAY BE DELETED IF THE FLAGGERS ARE IN SIGHT OF EACH OTHER, OR IF A PILOT CAR IS USED ON A TWO LANE ROADWAY.
- 714 OMITTED
- 715 ALL CONTRACTOR'S EMPLOYEES' PERSONAL VEHICLES, AND CONTRACTOR'S EQUIPMENT NOT IN OPERATION, SHALL BE PARKED A MINIMUM OF THIRTY (30) FEET FROM THE TRAVELED WAY DURING WORKING HOURS, AS NOT TO CREATE A HAZARD.
- 716 THE TRAFFIC CONTROL PLAN IS NOT ALL INCLUSIVE. THE TCP PROVIDES SEVERAL DETAILED DRAWINGS INDICATING THE TRAFFIC CONTROL NECESSARY FOR THE DIFFERENT CONSTRUCTION ACTIVITIES ANTICIPATED FOR THIS PROJECT. THE CONTRACTOR SHALL SELECT THE DETAILED DRAWING THAT BEST FITS THE ACTIVITY TO BE PERFORMED.
- 717 OMITTED
- 718 REQUIRED TEMPORARY ROUTE MARKER ASSEMBLIES THAT ARE TO BE LOCATED IN THE VICINITY OF EXISTING ROUTE MARKERS SHOULD BE PLACED ALONG SIDE OF THOSE ALREADY IN PLACE. SOME EXISTING ROUTE MARKERS MAY HAVE TO BE COVERED OR REMOVED, AS DIRECTED BY THE ENGINEER. COST SHALL BE A SUBSIDIARY OBLIGATION OF ITEM 740B.



REVISIONS 1. Modified Note 748 f 2. Aligned text for Note

## GENERAL TRAFFIC CONTROL PLAN NOTES

719	OMITTED	748 R
720	ALL TRAFFIC CONTROL DEVICES THAT ARE NOT APPLICABLE AT ANY SPECIFIC TIME SHALL BE COVERED OR REMOVED AS DIRECTED BY THE ENGINEER.	(END I STATE AT TH SPEED ZONE
721	OMITTED	THREE
722	OMITTED	749
723	THE CONTRACTOR SHALL MAKE PROVISIONS FOR THE SAFETY OF PEDESTRIAN TRAFFIC CROSSING THE WORK ZONES DURING CONSTRUCTION.	
724	OMITTED	750
725	ALL SIGNS SHALL BE POST-MOUNTED IF THE WORK PERIOD EXCEEDS FOUR DAYS, EXCEPT FOR THOSE SIGNS WHICH ARE MOUNTED ON BARRICADES. FOR REPEATED DAY OPERATIONS, SIGNS MAY BE MOUNTED ON TEMPORARY SUPPORTS AND REMOVED AT THE COMPLETION OF THE DAY'S OPERATION.	751
726	W8 SIGNS INTENDED TO WARN MOTORISTS OF SURFACE CONDITIONS EXTENDING FOR GREATER THAN 1 MILE SHALL BE PLACED PRIOR TO THE BEGINNING OF SURFACE CONDITION AND AT 1 MILE INCREMENTS THEREAFTER, WITH THE EXCEPTION SPECIFIED IN NOTE 727.	752
727	DURING THE WIDENING OR RESURFACING OF ANY ROADWAY CARRYING TRAFFIC, THE CONTRACTOR SHALL ADVISE THE MOTORISTS OF ANY EDGE OF PAVEMENT DROP-OFFS 3 INCHES OR GREATER BY PLACING SHOULDER DROP- OFF SIGNS EVERY ½ MILE BEGINNING PRIOR TO THE WIDENING OR RESURFACING. REQUIRED SHOULDER WORK TO ELIMINATE THE DROP- OFFS SHALL BE PURSUED IN AN EXPEDITIOUS MANNER FOLLOWING THE WIDENING AND/OR RESURFACING.	
728	A DIFFERENCE IN ELEVATION OF APPROXIMATELY 2 INCHES OR LESS AT THE CENTERLINE MAY BE ALLOWED DURING NON-WORKING HOURS WITHOUT ADDITIONAL TRAFFIC CONTROL. SPECIAL CONDITIONS MAY EXIST WHERE PROTECTION SHOULD BE PROVIDED WHERE THE DIFFERENCE IS 2 INCHES OR LESS.	
729	SIGNS ON TEMPORARY SUPPORTS ARE TO BE REMOVED OR COVERED WHEN NO WORK IS BEING PERFORMED OR AT THE COMPLETION OF THE DAY'S OPERATION.	
730	OMITTED	
731	OMITTED	
732	CHANNELIZING DRUMS SHOULD BE PLACED ON 10 FOOT INTERVALS IN RADII.	
733	CHANNELIZING DRUMS PLACED TO PROTECT COMPLETED WORK NOT OPEN TO TRAFFIC, SHOULD BE SPACED AT 50 FOOT INTERVALS.	
734	CHANNELIZING DRUMS PLACED IN THE EXCAVATED AREA AHEAD OF PAVING OPERATIONS, SHOULD BE SPACED AT 50 FOOT INTERVALS.	
735	CHANNELIZING DRUMS PLACED ON PAVEMENT DURING WORKING HOURS SHALL BE SHIFTED TO THE EDGE OF SHOULDER DURING NON-WORKING HOURS AND DURING PEAK PERIODS.	
736	CHANNELIZING DRUMS SHOULD BE PLACED ON 25 FOOT INTERVALS THROUGHOUT ALL TAPERS.	
737	CHANNELIZING DEVICES SHALL EXTEND TO A POINT WHERE THEY ARE VISIBLE TO APPROACHING TRAFFIC.	
738	OMITTED	
739	OMITTED	
740	OMITTED	
741	FOR DIVIDED ROADWAYS, THE REQUIRED ADVANCE WARNING SIGNS SHALL BE POSTED ON BOTH THE RIGHT AND LEFT SIDE OF THE ROADWAY.	
742	THE CONTRACTOR SHALL CLOSE THE LANE ADJACENT TO THE WORK AREA ANYTIME WORK OUTSIDE THE EXISTING TRAVEL LANES ENCROACHES WITHIN 2 FEET OF THE EXISTING EDGE OF PAVEMENT.	
743	OMITTED	
744	THE TRANSITION TAPER LENGTH (L) IS SHOWN IN TABLE 6C-4, AND THE BUFFER LENGTH IS SHOWN IN TABLE 6C-2 OF THE MUTCD, PART 6, 2009 EDITION.	
745	OMITTED	
746	UNEVEN LANES SIGNS SHALL BE COVERED OR REMOVED WHEN NO UNEVEN PAVEMENT CONDITIONS EXIST.	
747	MOVING OPERATIONS SHALL BE CONFINED TO ONE LANE IN THE DIRECTION OF TRAFFIC.	

or the addition of the R13-3b sign on 9-28-2021 by D.J.W.	Bureau Std Engr:D.J.W	DESIGN BUREAU SPECIAL DRAWING
e 746 on 12-8-2021 by D.J.W.	DRAWN BY: DATE DRAWN: REVISED DATE: <u>12-8-2021</u>	GENERAL TRAFFIC CONTRO PLAN NOTES


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<ul> <li>HIGHER FINES) SIGNS SHALL BE REQUIRED FOR EVERY PROJECT ON ENOUTES AND INTERSTATE HIGHWAYS. THESE SIGNS SHALL BE POSTED E BEGINNING AND END OF THE PROJECT WITH AN R2-1 (REGULATORY O SIGN) ALWAYS FOLLOWING THE RIG-3 SIGN. R16-3B (ING. R16-3B) HURDES THROUGHOUT THE PROJECT LIMITS.</li> <li>WIEN A CONSTRUCTION WORK ZONE SPEED LIMIT REDUCTION IS NOT REQUIRED AT THE END OF THE WORK DAY, THE CONTRACTOR SIGNS AND THE UND OF THE WORK DAY, THE CONTRACTOR SIGNS) AND THE W3-5B (REDUCED SPEED AHEAD) SIGNS UNLESS OTHERWISE DIRECTED BY THE ENGINEER.</li> <li>DURING REPLACEMENT OF GUARDRAIL AND/OR GUARDRAIL END ANCHORS, A REFLECTORIZED DRUM SHALL BE PLACED BEFORE THE END OF ANY EXPOSED GUARDRAIL AN INFORMATION SHOULD BY ANCHOR CANNOT BE REPLACED IN ONE DAY'S TIME.</li> <li>CONSTRUCTION SIGNS MOUNTED ON A SINGULAR OR DUAL SQUARE TUBULAR OR U-CHANNEL POST SHALL BE INSTALLED AS SHOWN ON SPECIAL DRAWING NOS. IHS-710-21 AND IHS-710-23.</li> <li>THE CONTRACTOR AND THE CONSTRUCTION ENGINEER SHALL DISCUSS AND PLAN FOR THE HANDLING OF TRAFFIC FOR ALL HOLIDAYS BEFORE ANY WORK BEGINS. UNLESS OTHERWISE PRE- APPROVED BY THE REGION ENGINEER, THE FOLLOWING SHALL HOLD:</li> <li>THE CONTRACTOR SHALL NOT HAVE A LANE CLOSURE DURING THE FORM L1:59 PM DECEMBER 23 THROUGH 6:00 AM JANUARY 2.</li> <li>FOR CHRISTMAS AND NEW YEARS DAY: FROM 11:59 PM DECEMBER 23 THROUGH 6:00 AM JANUARY 2.</li> <li>FOR CHRISTMAS AND NEW YEARS DAY: FROM 11:59 PM THE DAY OF THE HOLIDAY.</li> <li>FOR INDEPENDENCE DAY (THE 4TH OF JULY): FROM 12:00 NOON THE FRIDAY BEFORE THE HOLIDAY THROUGH 11:59 PM THE DAY OF THE HOLIDAY.</li> <li>FOR NATIONAL MEMORIAL DAY AND LABOR DAY: FROM 11:59 PM THE DAY OF THE HOLIDAY.</li> <li>FOR MALOOT:</li> <li>FOR THANKSGIVING DAY: FROM 11:59 PM THE DAY OF THE HOLIDAY.</li> <li>FOR NATIONAL MEMORIAL DAY AND LABOR DAY: FROM 11:59 PM THE DAY OF THE HOLIDAY.</li> <li>FOR NATIONAL MEMORIAL DAY AND LABOR DAY: FROM 11:59 PM THE DAY OF THE HOLIDAY.</li> <li>FOR THANKSGIVING DAY: FROM 11:59 PM THE DAY OF THE HOLIDAY.</li> <li>FOR MIDEPENDENCE DA</li></ul>		RALCP 41-146-24		
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NOT TO SCALE

--SPECIFICATIONS--CURRENT ALABAMA DEPARTMENT OF TRANSPORTATION SPECIAL DRAWING NO INDEX NO

ERAL TRAFFIC CONTROL PLAN NOTES

SPECIAL PROJECT DETAIL

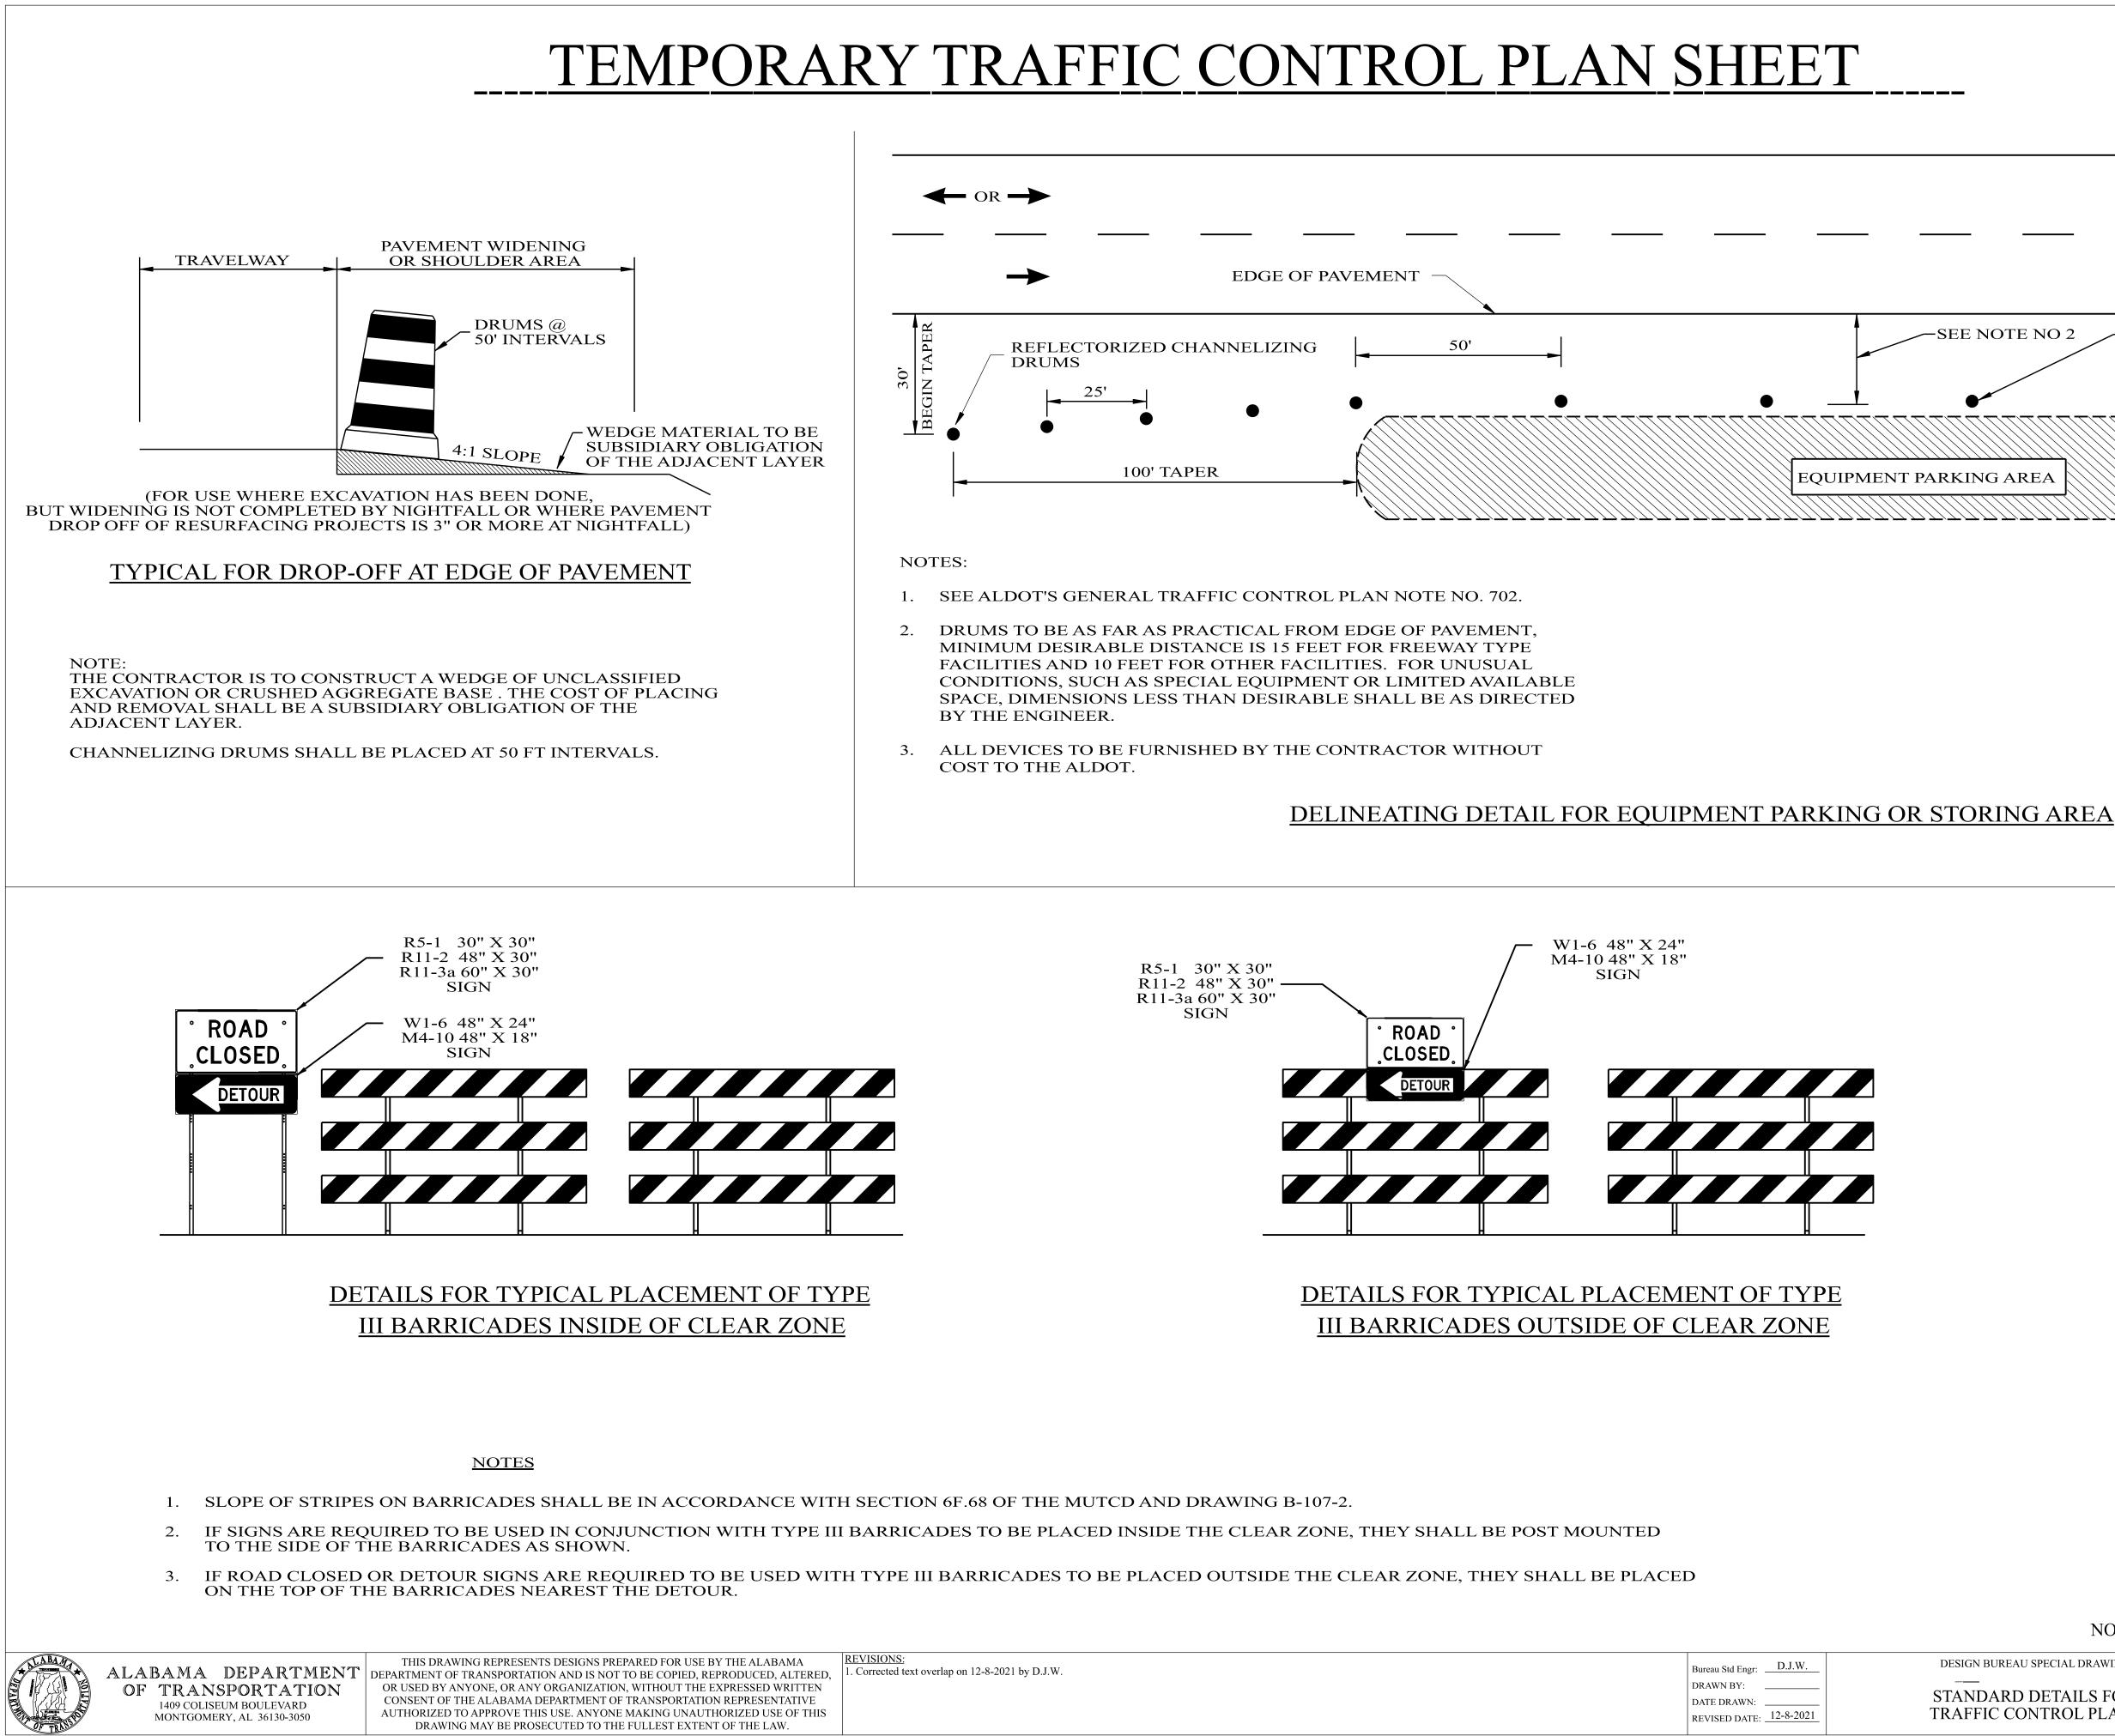

verlap on 12-8-2021 by D.J.W.	Bureau Std Engr:D.J.W	DE
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	REVISED DATE: <u>12-8-2021</u>	TRA
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--SPECIFICATIONS--CURRENT ALABAMA DEPARTMENT OF TRANSPORTATION

SIGN BUREAU SPECIAL DRAWING


ANDARD DETAILS FOR RAFFIC CONTROL PLANS

SPECIAL PROJECT DETAIL

SPECIAL DRAWING NO

INDEX NO

# TEMPORARY TRAFFIC CONTROL PLAN SHEE

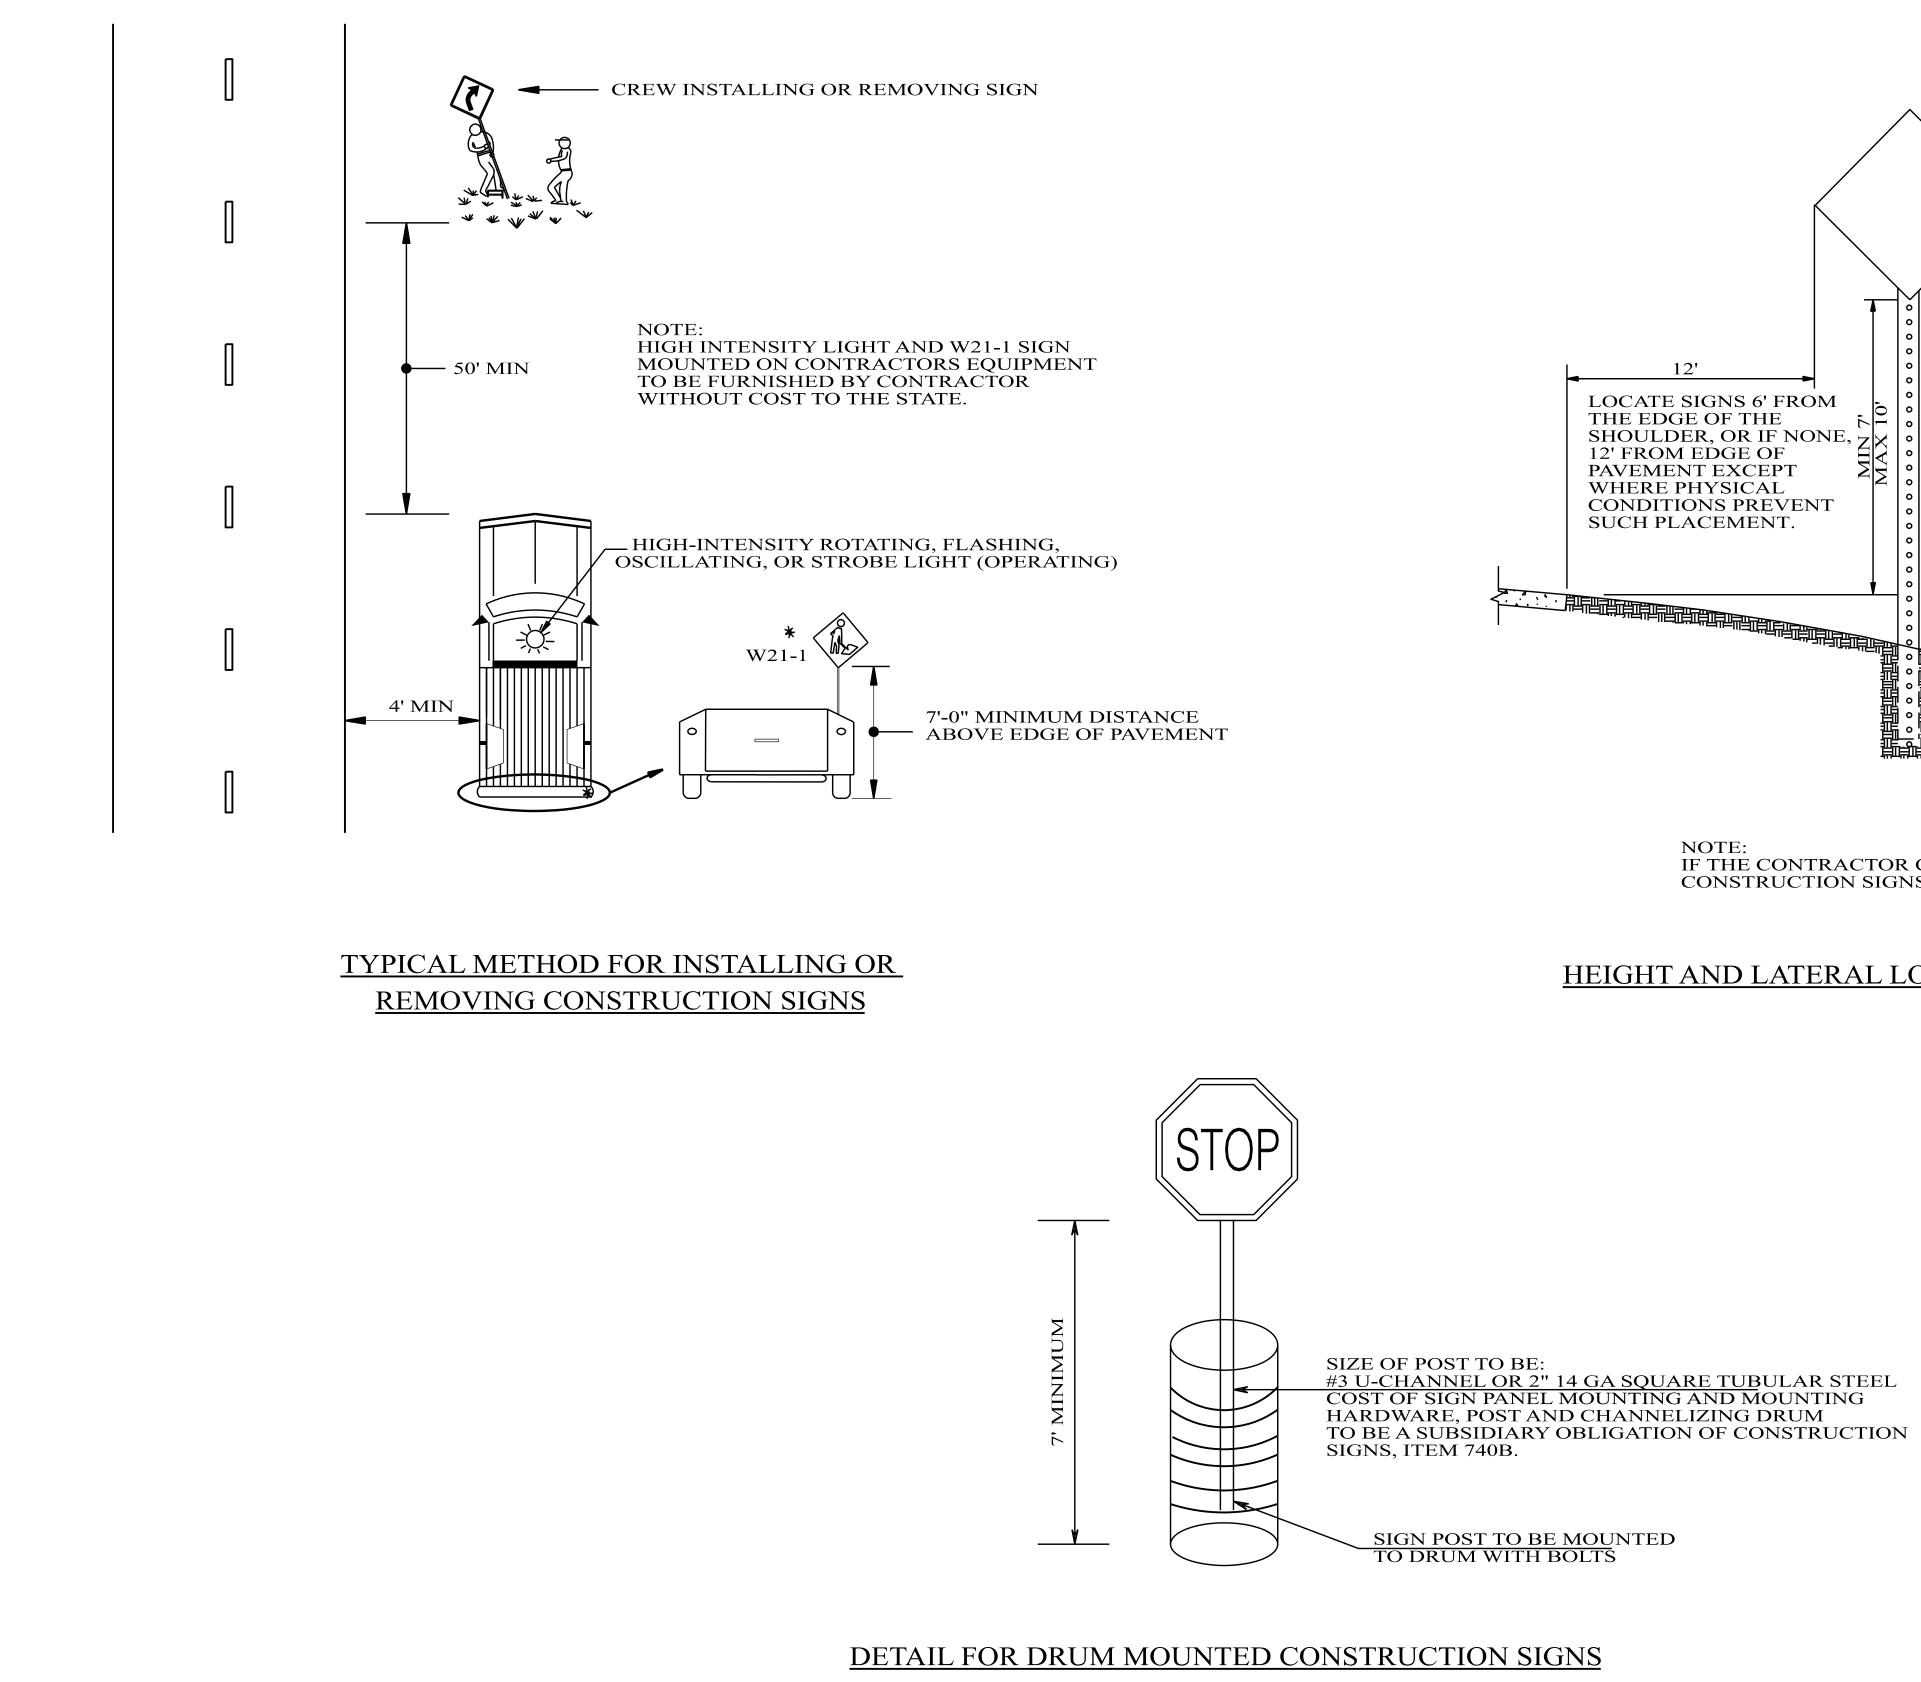




**REVISIONS:** THIS DRAWING REPRESENTS DESIGNS PREPARED FOR USE BY THE ALABAMA ALABAMA DEPARTMENT DEPARTMENT OF TRANSPORTATION AND IS NOT TO BE COPIED, REPRODUCED, ALTERED, OR USED BY ANYONE, OR ANY ORGANIZATION, WITHOUT THE EXPRESSED WRITTEN CONSENT OF THE ALABAMA DEPARTMENT OF TRANSPORTATION REPRESENTATIVE AUTHORIZED TO APPROVE THIS USE. ANYONE MAKING UNAUTHORIZED USE OF THIS DRAWING MAY BE PROSECUTED TO THE FULLEST EXTENT OF THE LAW.

IF THE CONTRACTOR CHOOSES TO SPLICE THE CONSTRUCTION SIGNS, THEY SHALL BE SPLICE

### HEIGHT AND LATERAL LOCATION OF POST M


DESIC	Bureau Std Engr:D.J.W	
_ ST	DRAWN BY:	
	DATE DRAWN: REVISED DATE: 6-12-2019	
	DATE DRAWN:	


	REFERENCE PROJECT NO	FISCAL YEAR	SHEET NO
ET	RALCP 41-146-24	2025	8H
12'         LOCATE SIGNS 6' FR         THE EDGE OF THE         SHOULDER, OR IF N         12' FROM EDGE OF         WHERE PHYSICAL         CONDITIONS PREVI         SUCH PLACEMENT.         CONSTRUCTION SIGN WITH         SECONDARY SIGN PLATE         EE POSTS FOR THE REQUIRED PO         CED AS SHOWN ON DRAWING IH         MOUNTED CONSTRUCTI	ST MOUNTED	2025	8
NOT TO SCALE	SPECIFICATIO CURRENT ALABAMA DEPARTMENT		
ESIGN BUREAU SPECIAL DRAWING STANDARD DETAILS TRAFFIC CONTROL PLANS	SPECIAL DRAWING NO	ETAIL	INDEX NO

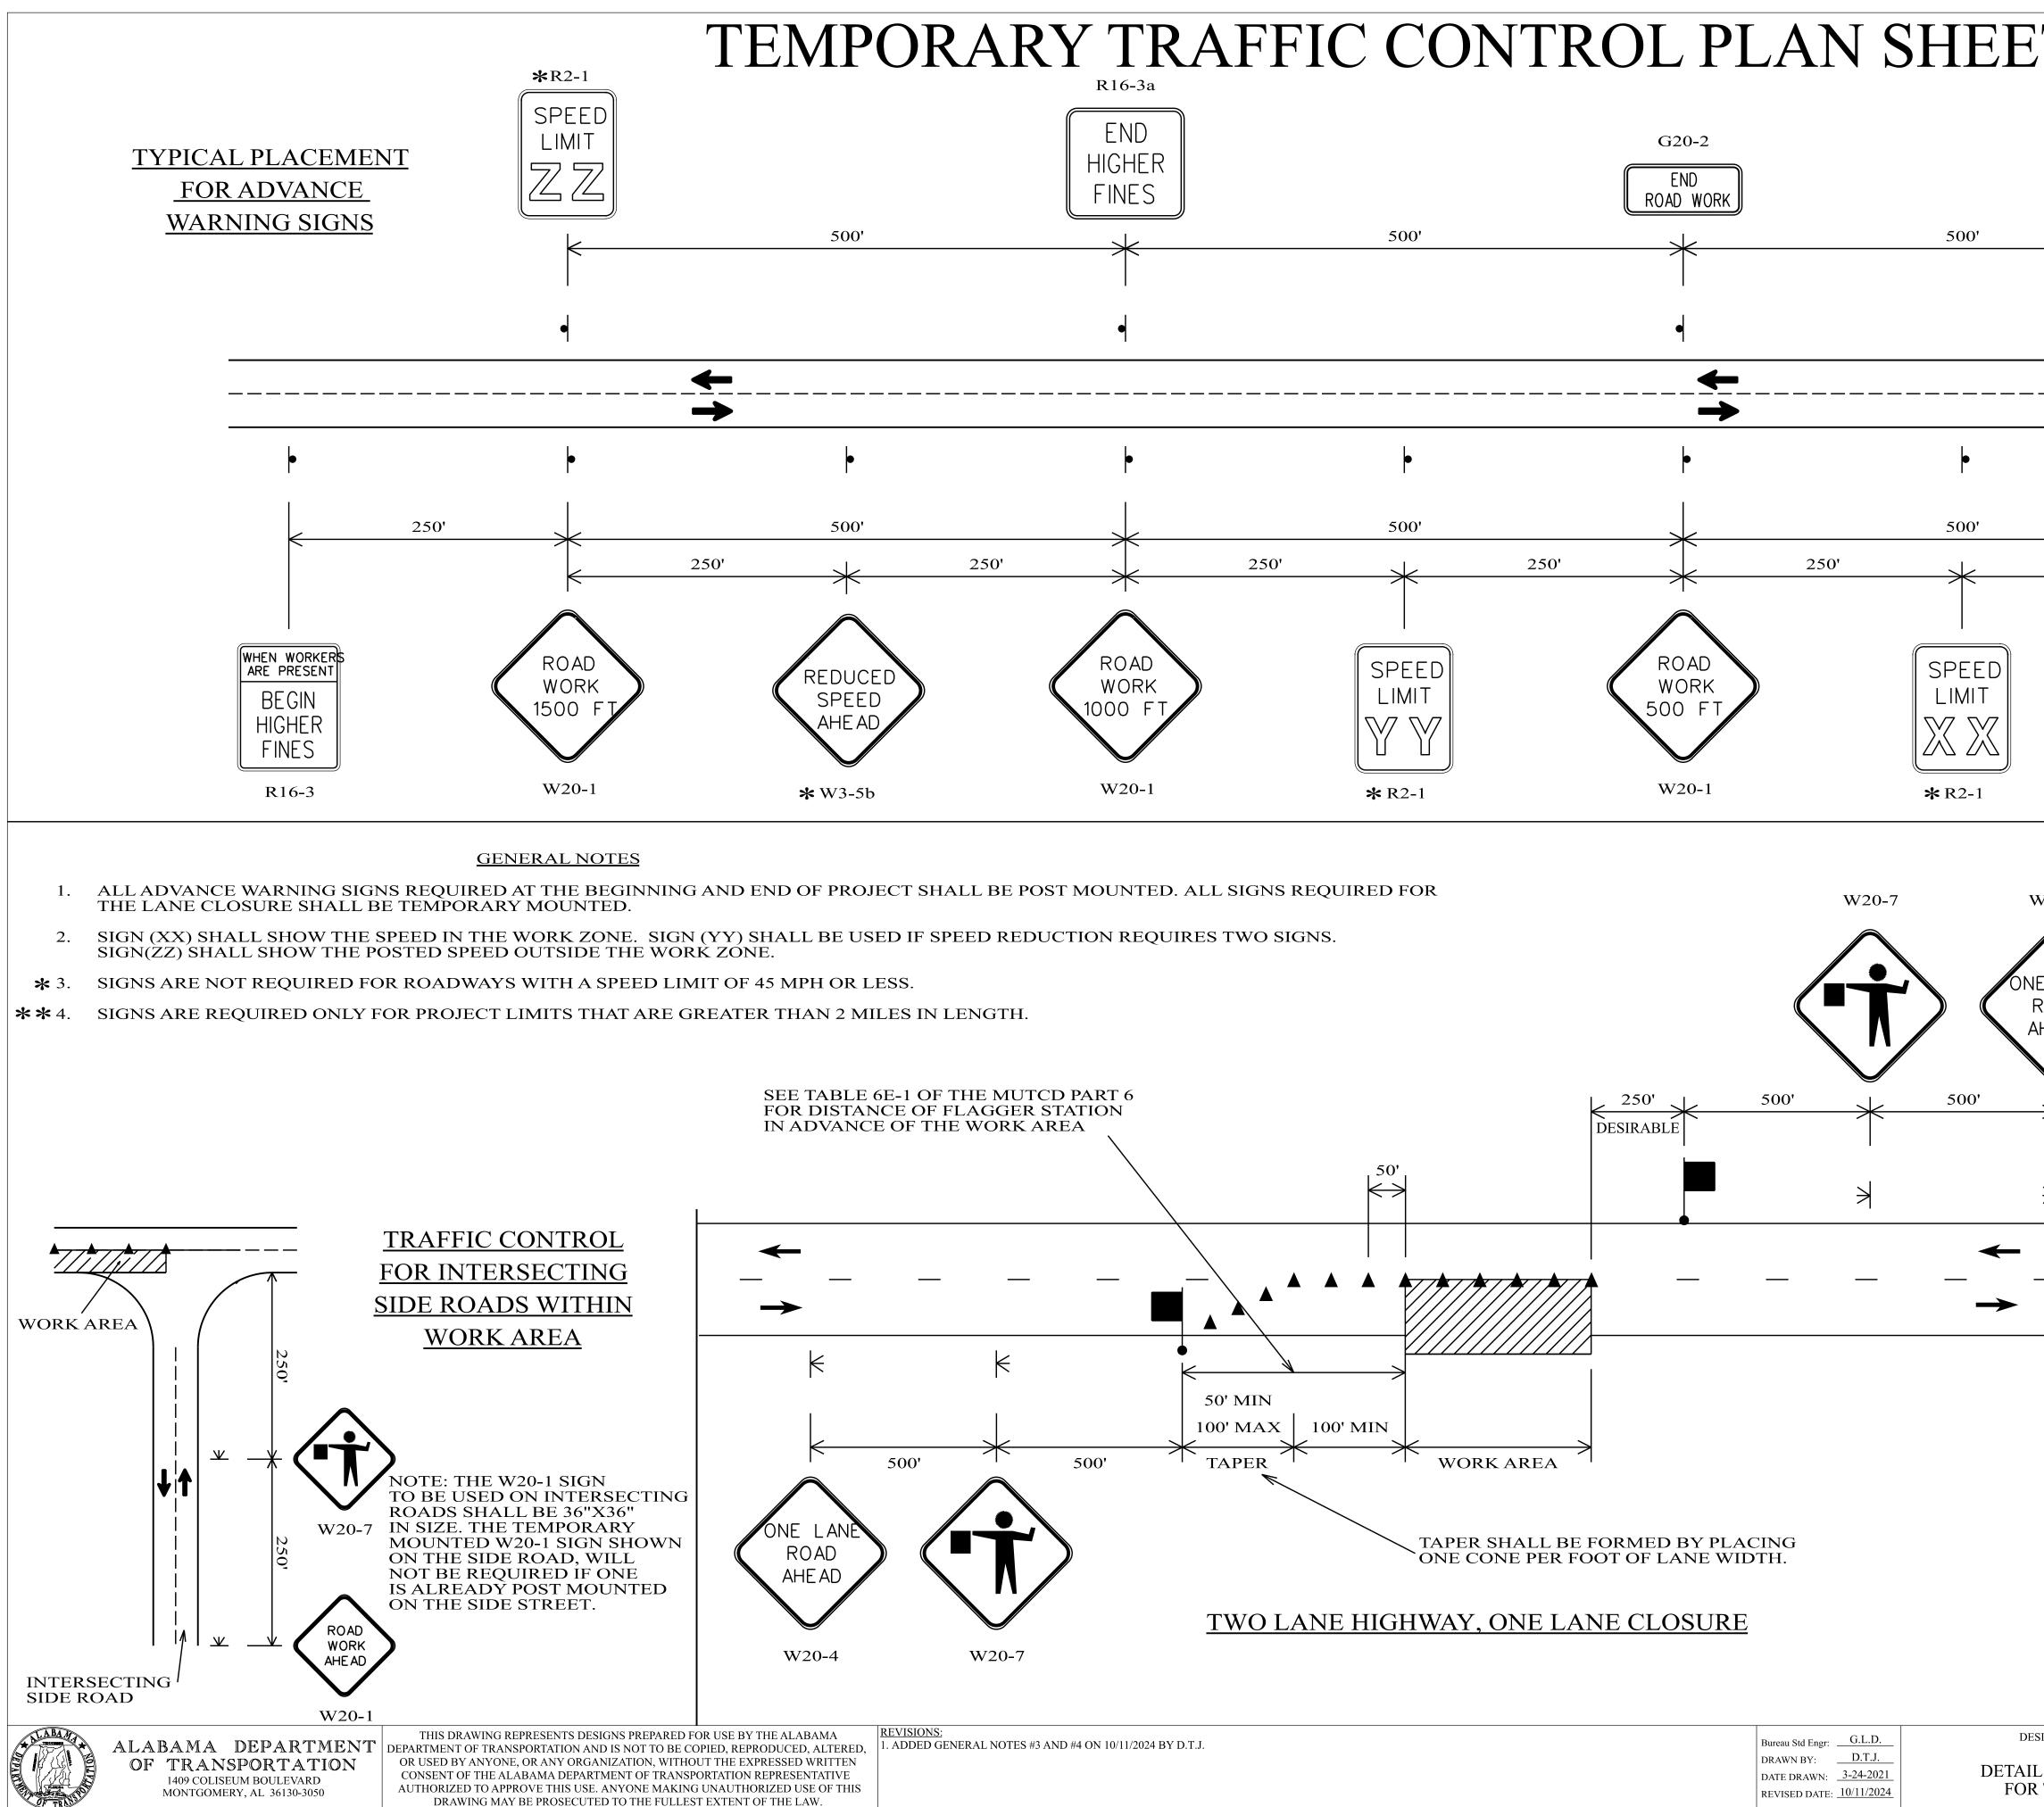



AL NOTES #3 AND #4 ON 10/11/2024 BY D.T.J.	Bureau Std Engr:G.L.D.	DESI
	DRAWN BY: D.T.J.	
	DATE DRAWN: <u>3-24-2021</u>	DETAIL
	REVISED DATE: <u>10/11/2024</u>	FOR


Τ	REFERENCE PROJECT NO	FISCAL YEAR	SHEET NO
1	RALCP 41-146-24	2025	81
	NOR END STATION		
SUPERCEI HIGHWAY	REQUIRED SIGN SIZES         G20-1       48" X 24"         G20-2       48" X 24"         R2-1       24" X 30"         W3-5b       48" X 48"         R16-3       48" X 48"         W20-1       48" X 48"         W20-2       48" X 48"         W20-3       48" X 48"         W20-4       48" X 48"         W20-7       48" X 48"	ANDARD	
	LEGEND TEMPORARY MOUNTED SIGN OST MOUNTED SIGN CONES LAGGER /ORK AREA	1	
NOT TO SCALE IGN BUREAU SPECIAL DRAWING S FOR TRAFFIC CONTROL TWO-LANE HIGHWAYS	SPECIFICATION CURRENT ALABAMA DEPARTMENT SPECIAL DRAWING NO SPECIAL PROJECT DE'	OF TRANSPOI	RTATION INDEX NO 2002

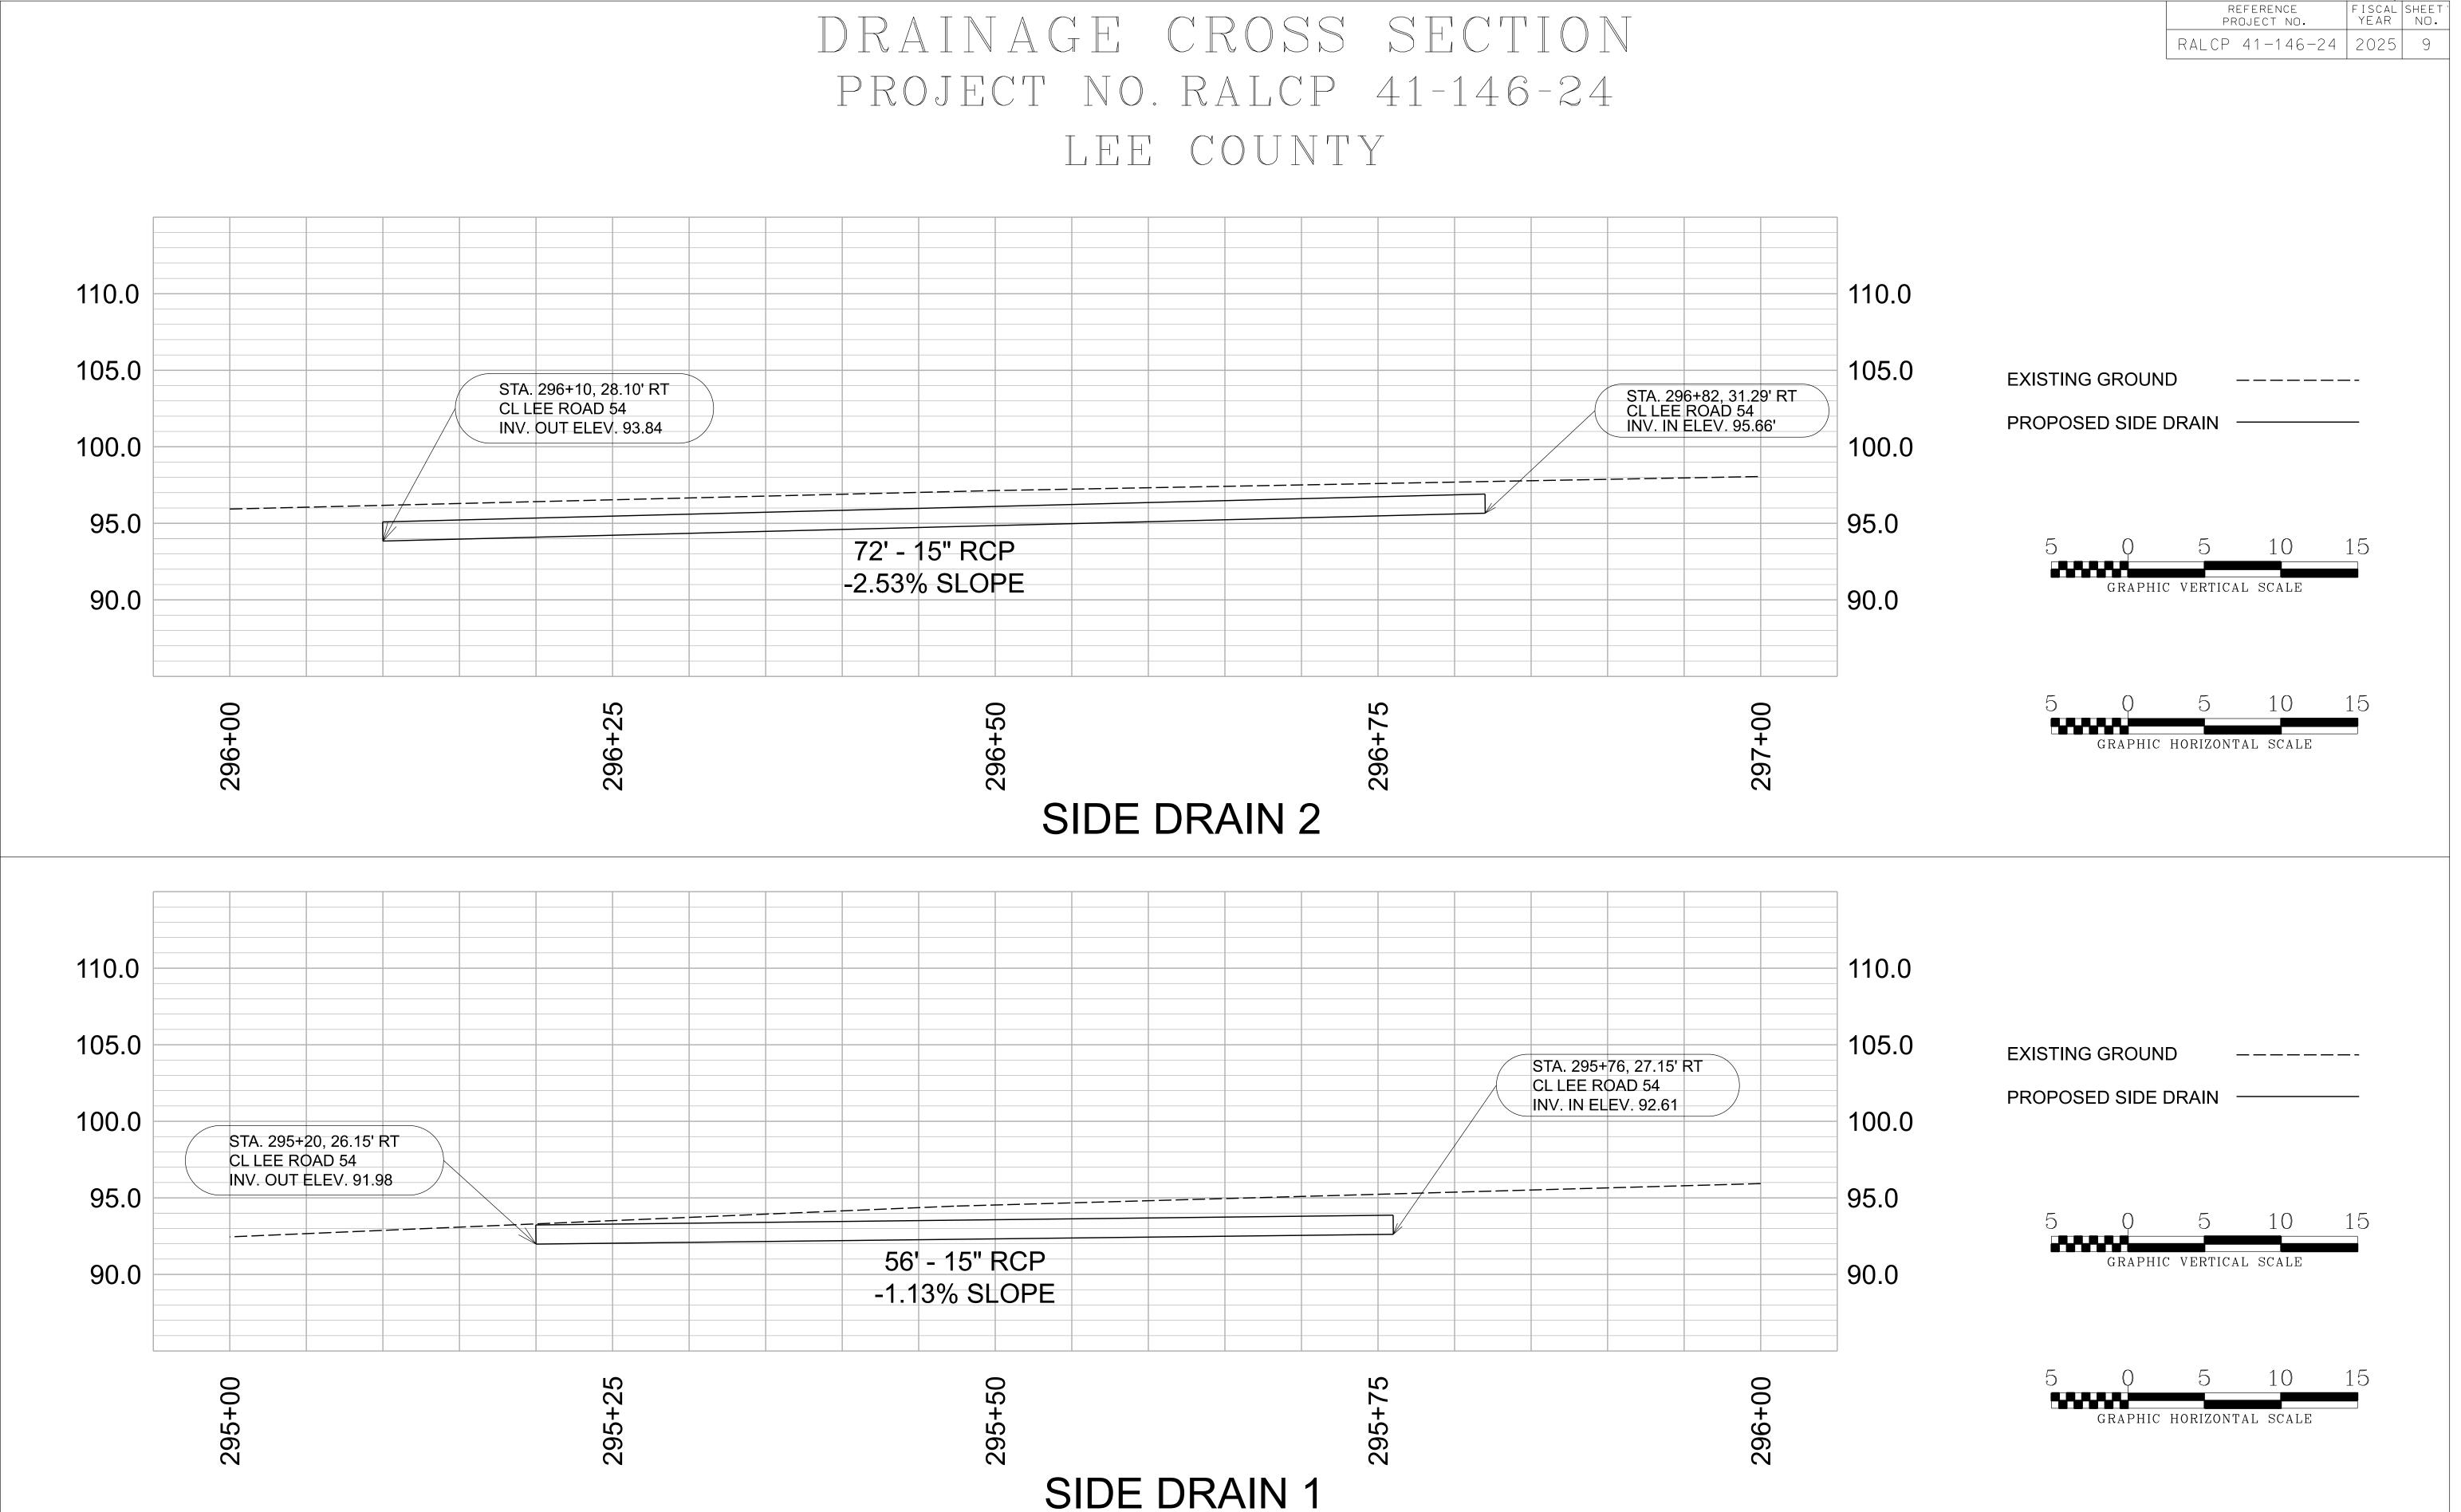


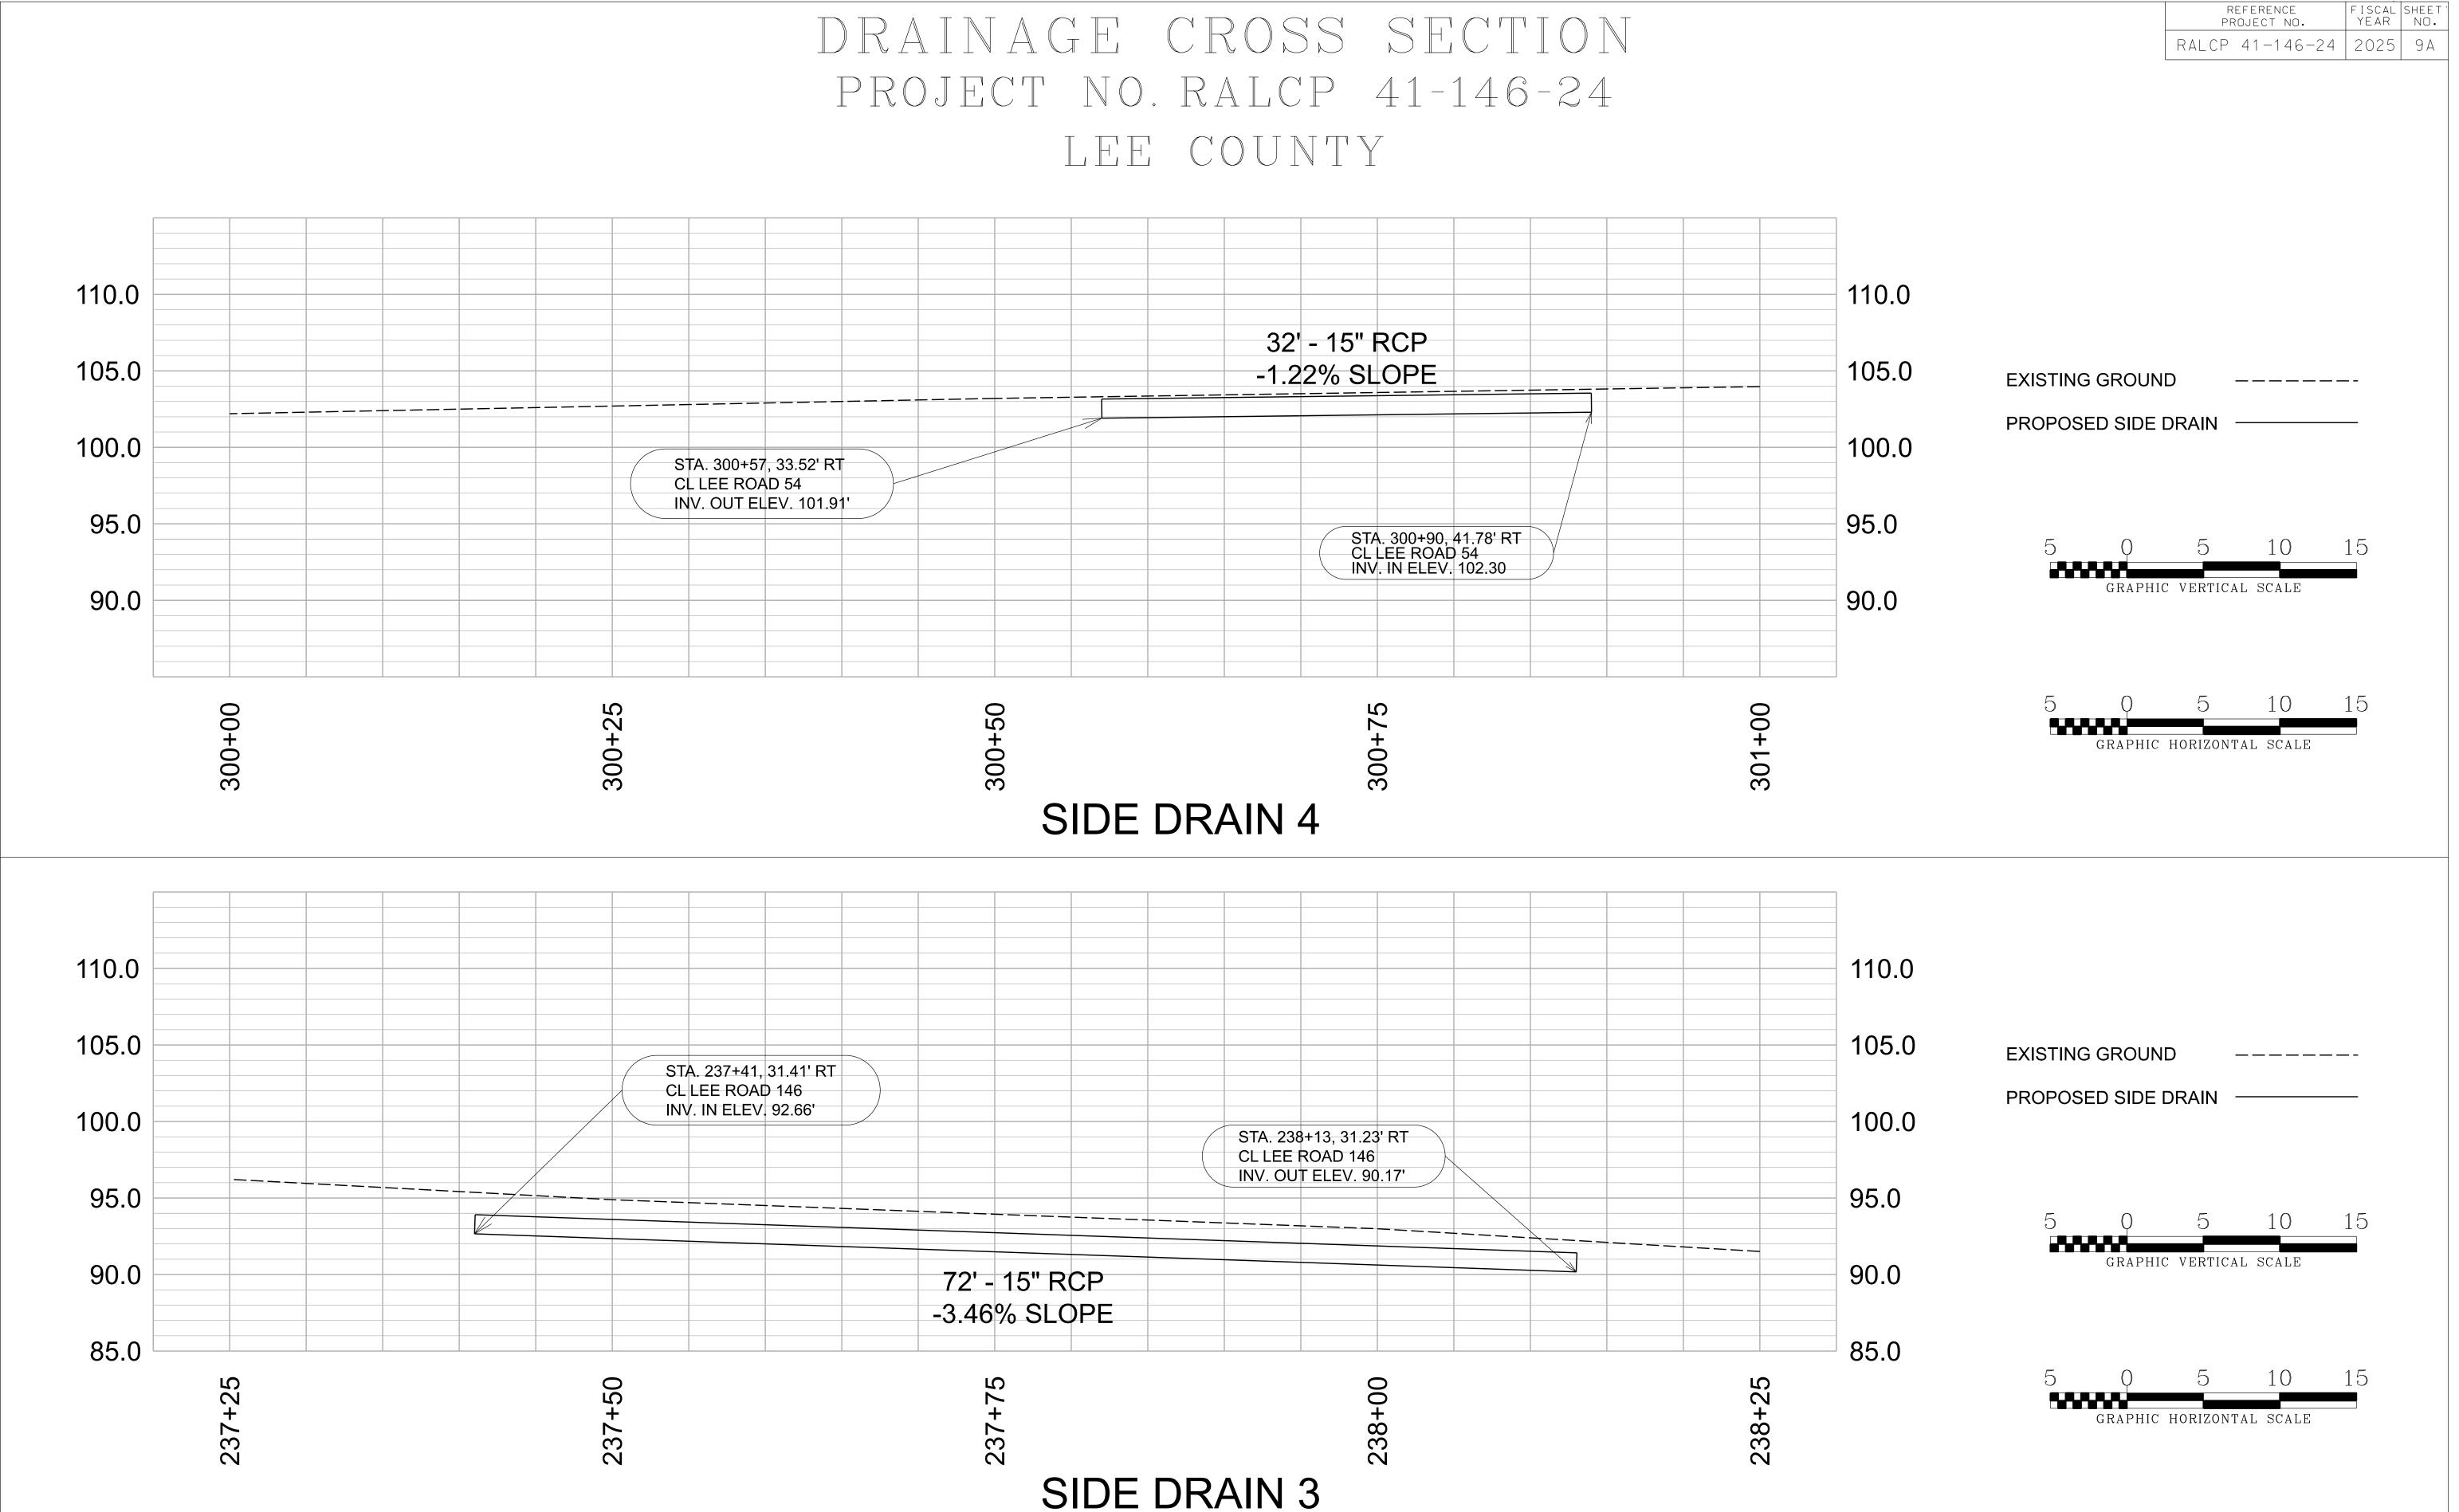

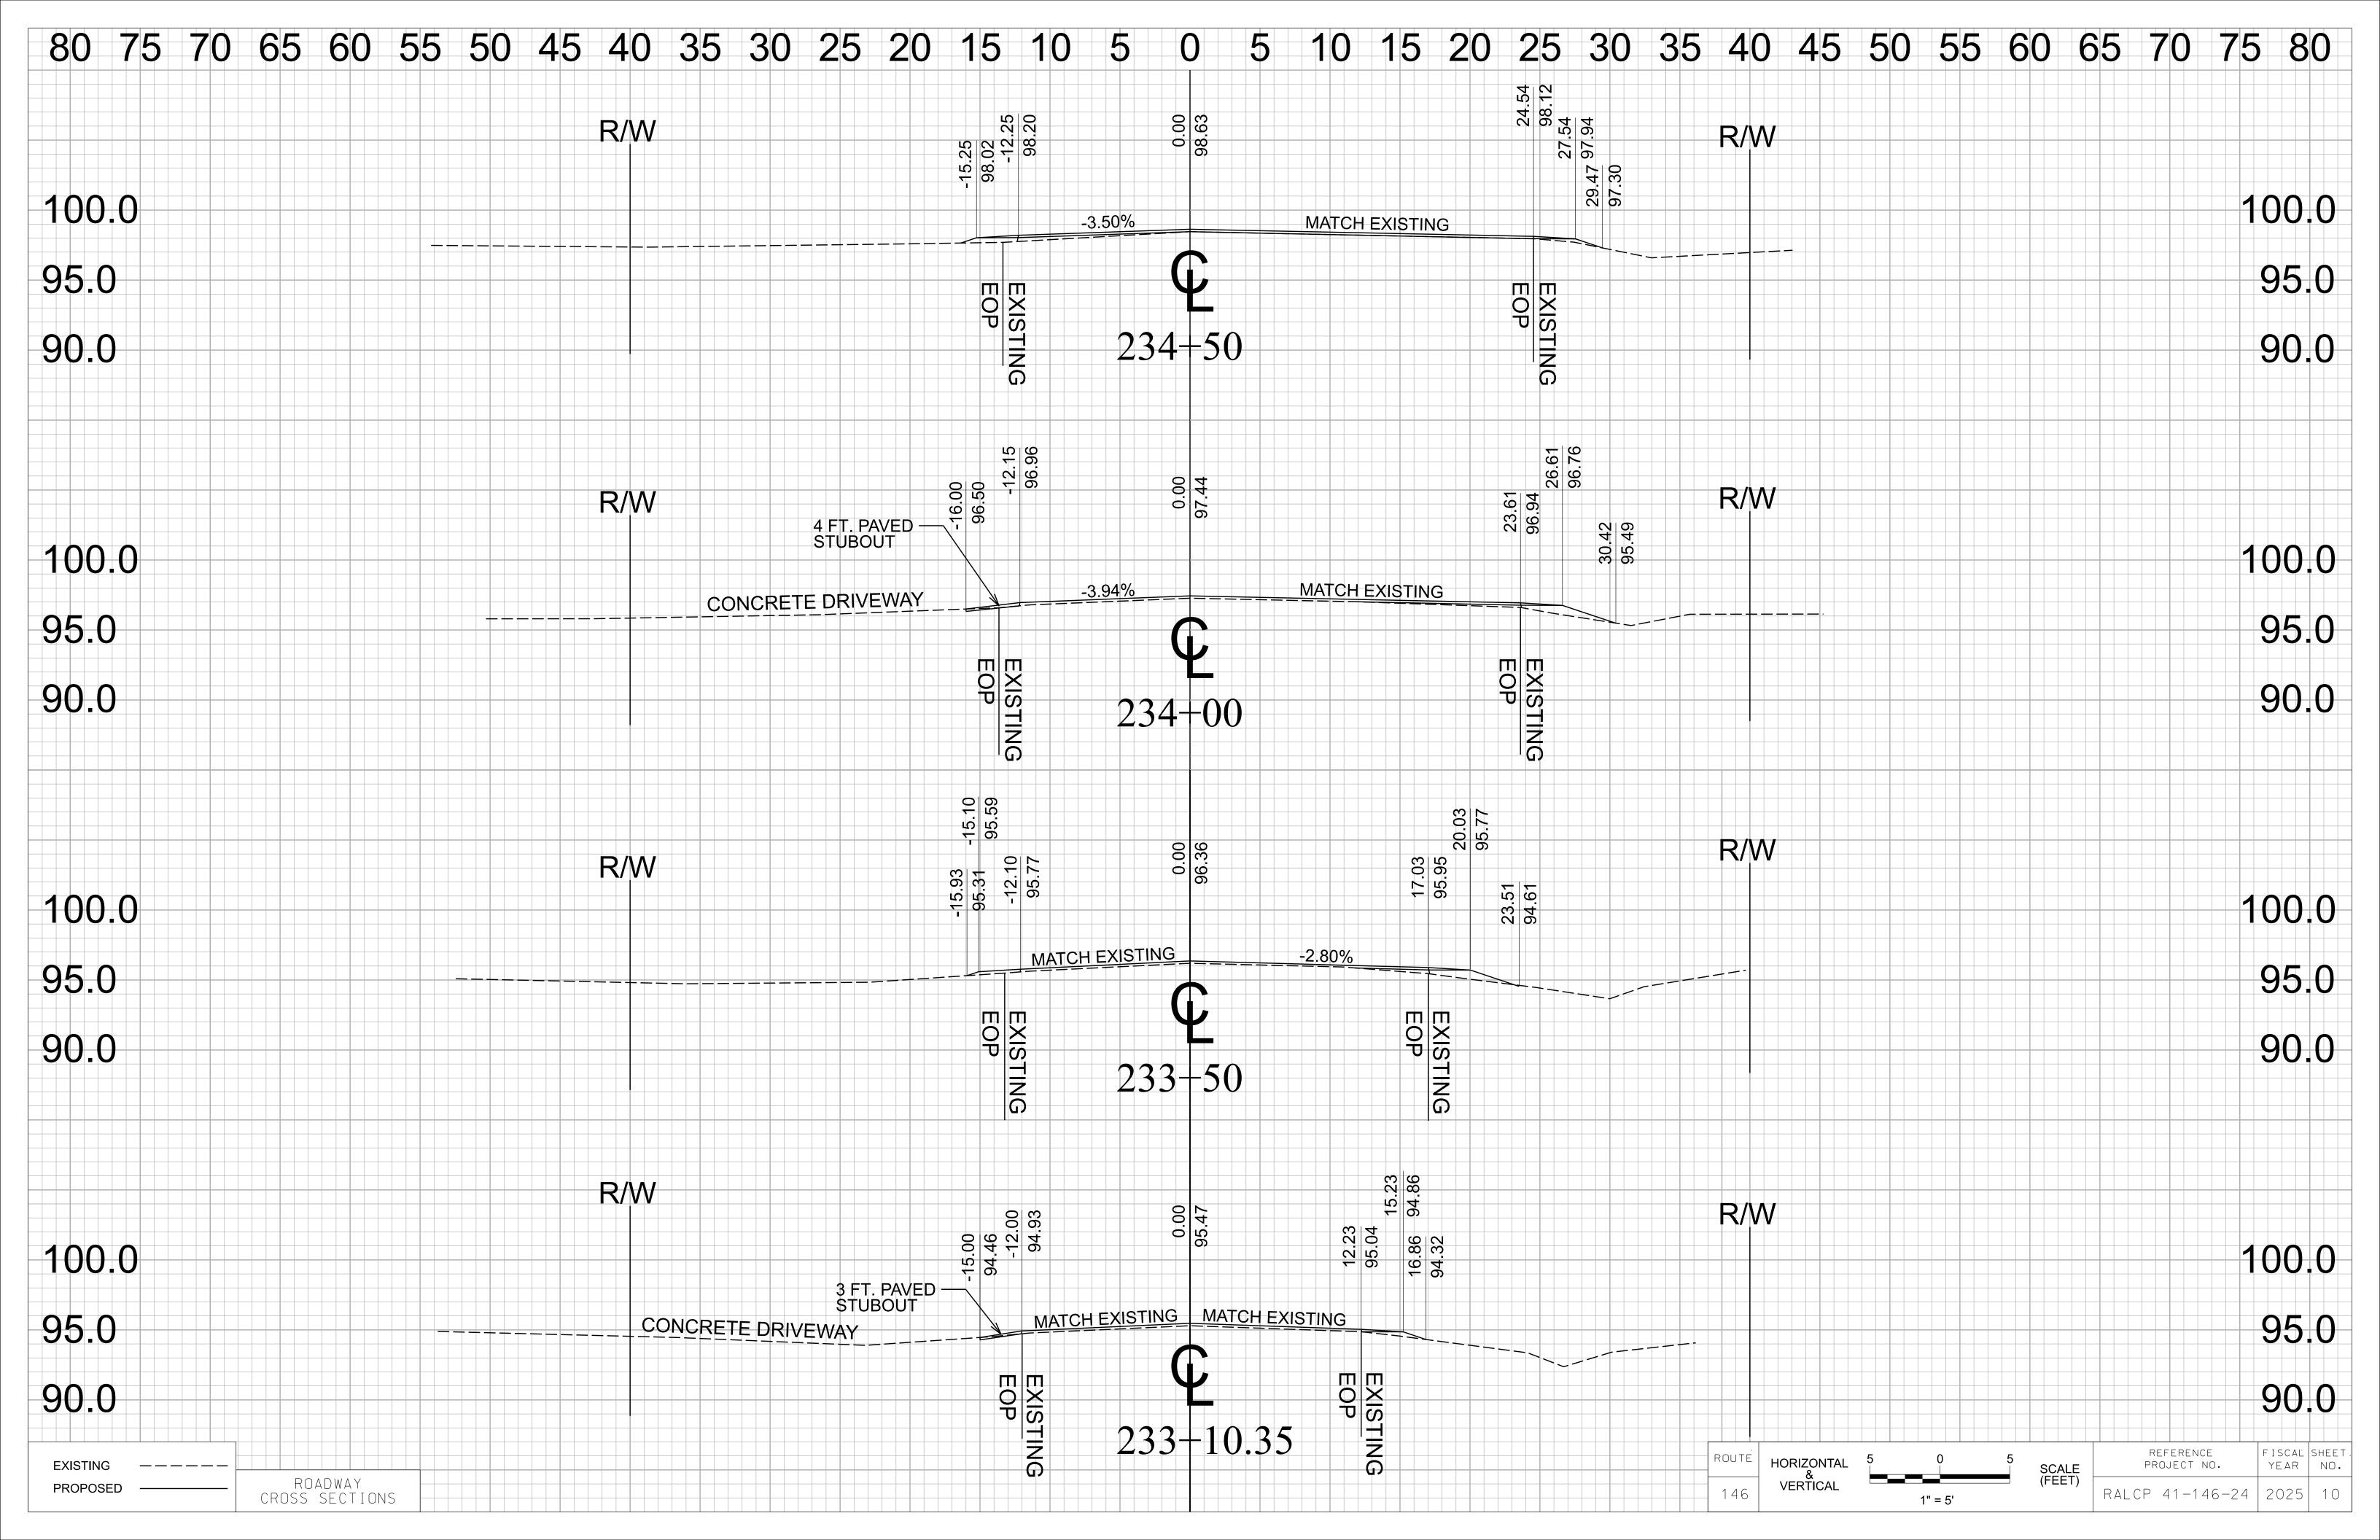

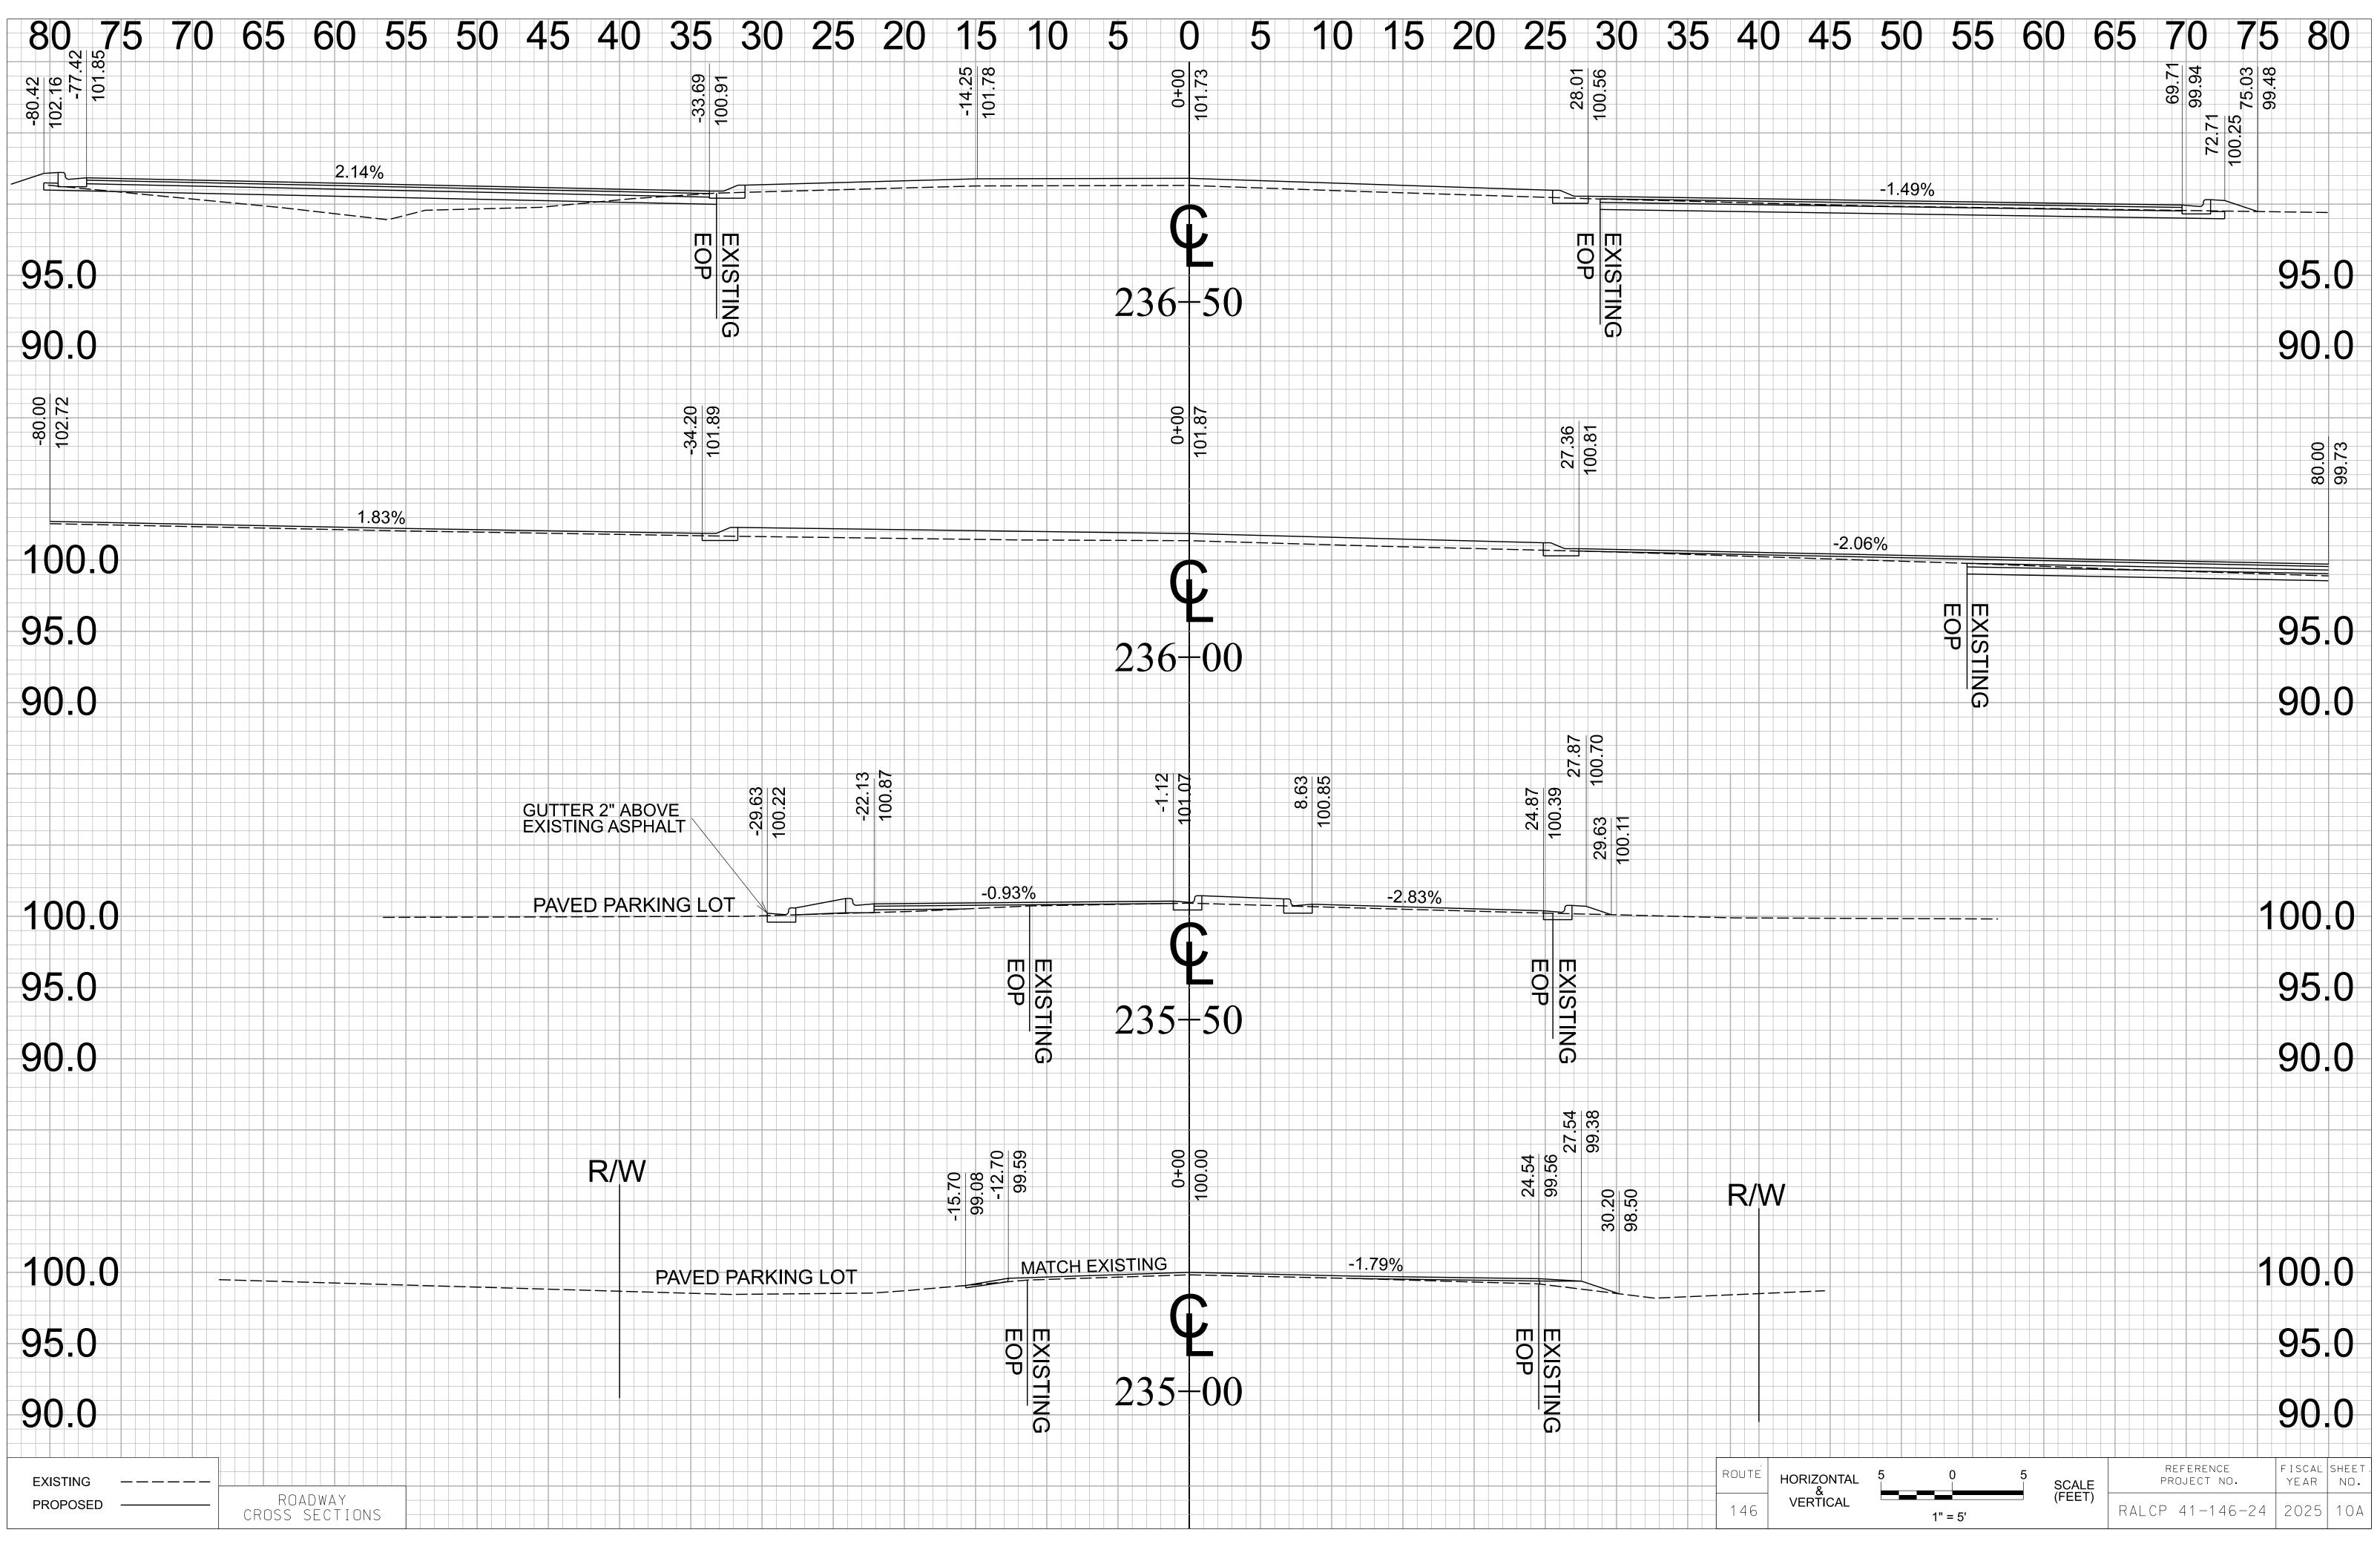

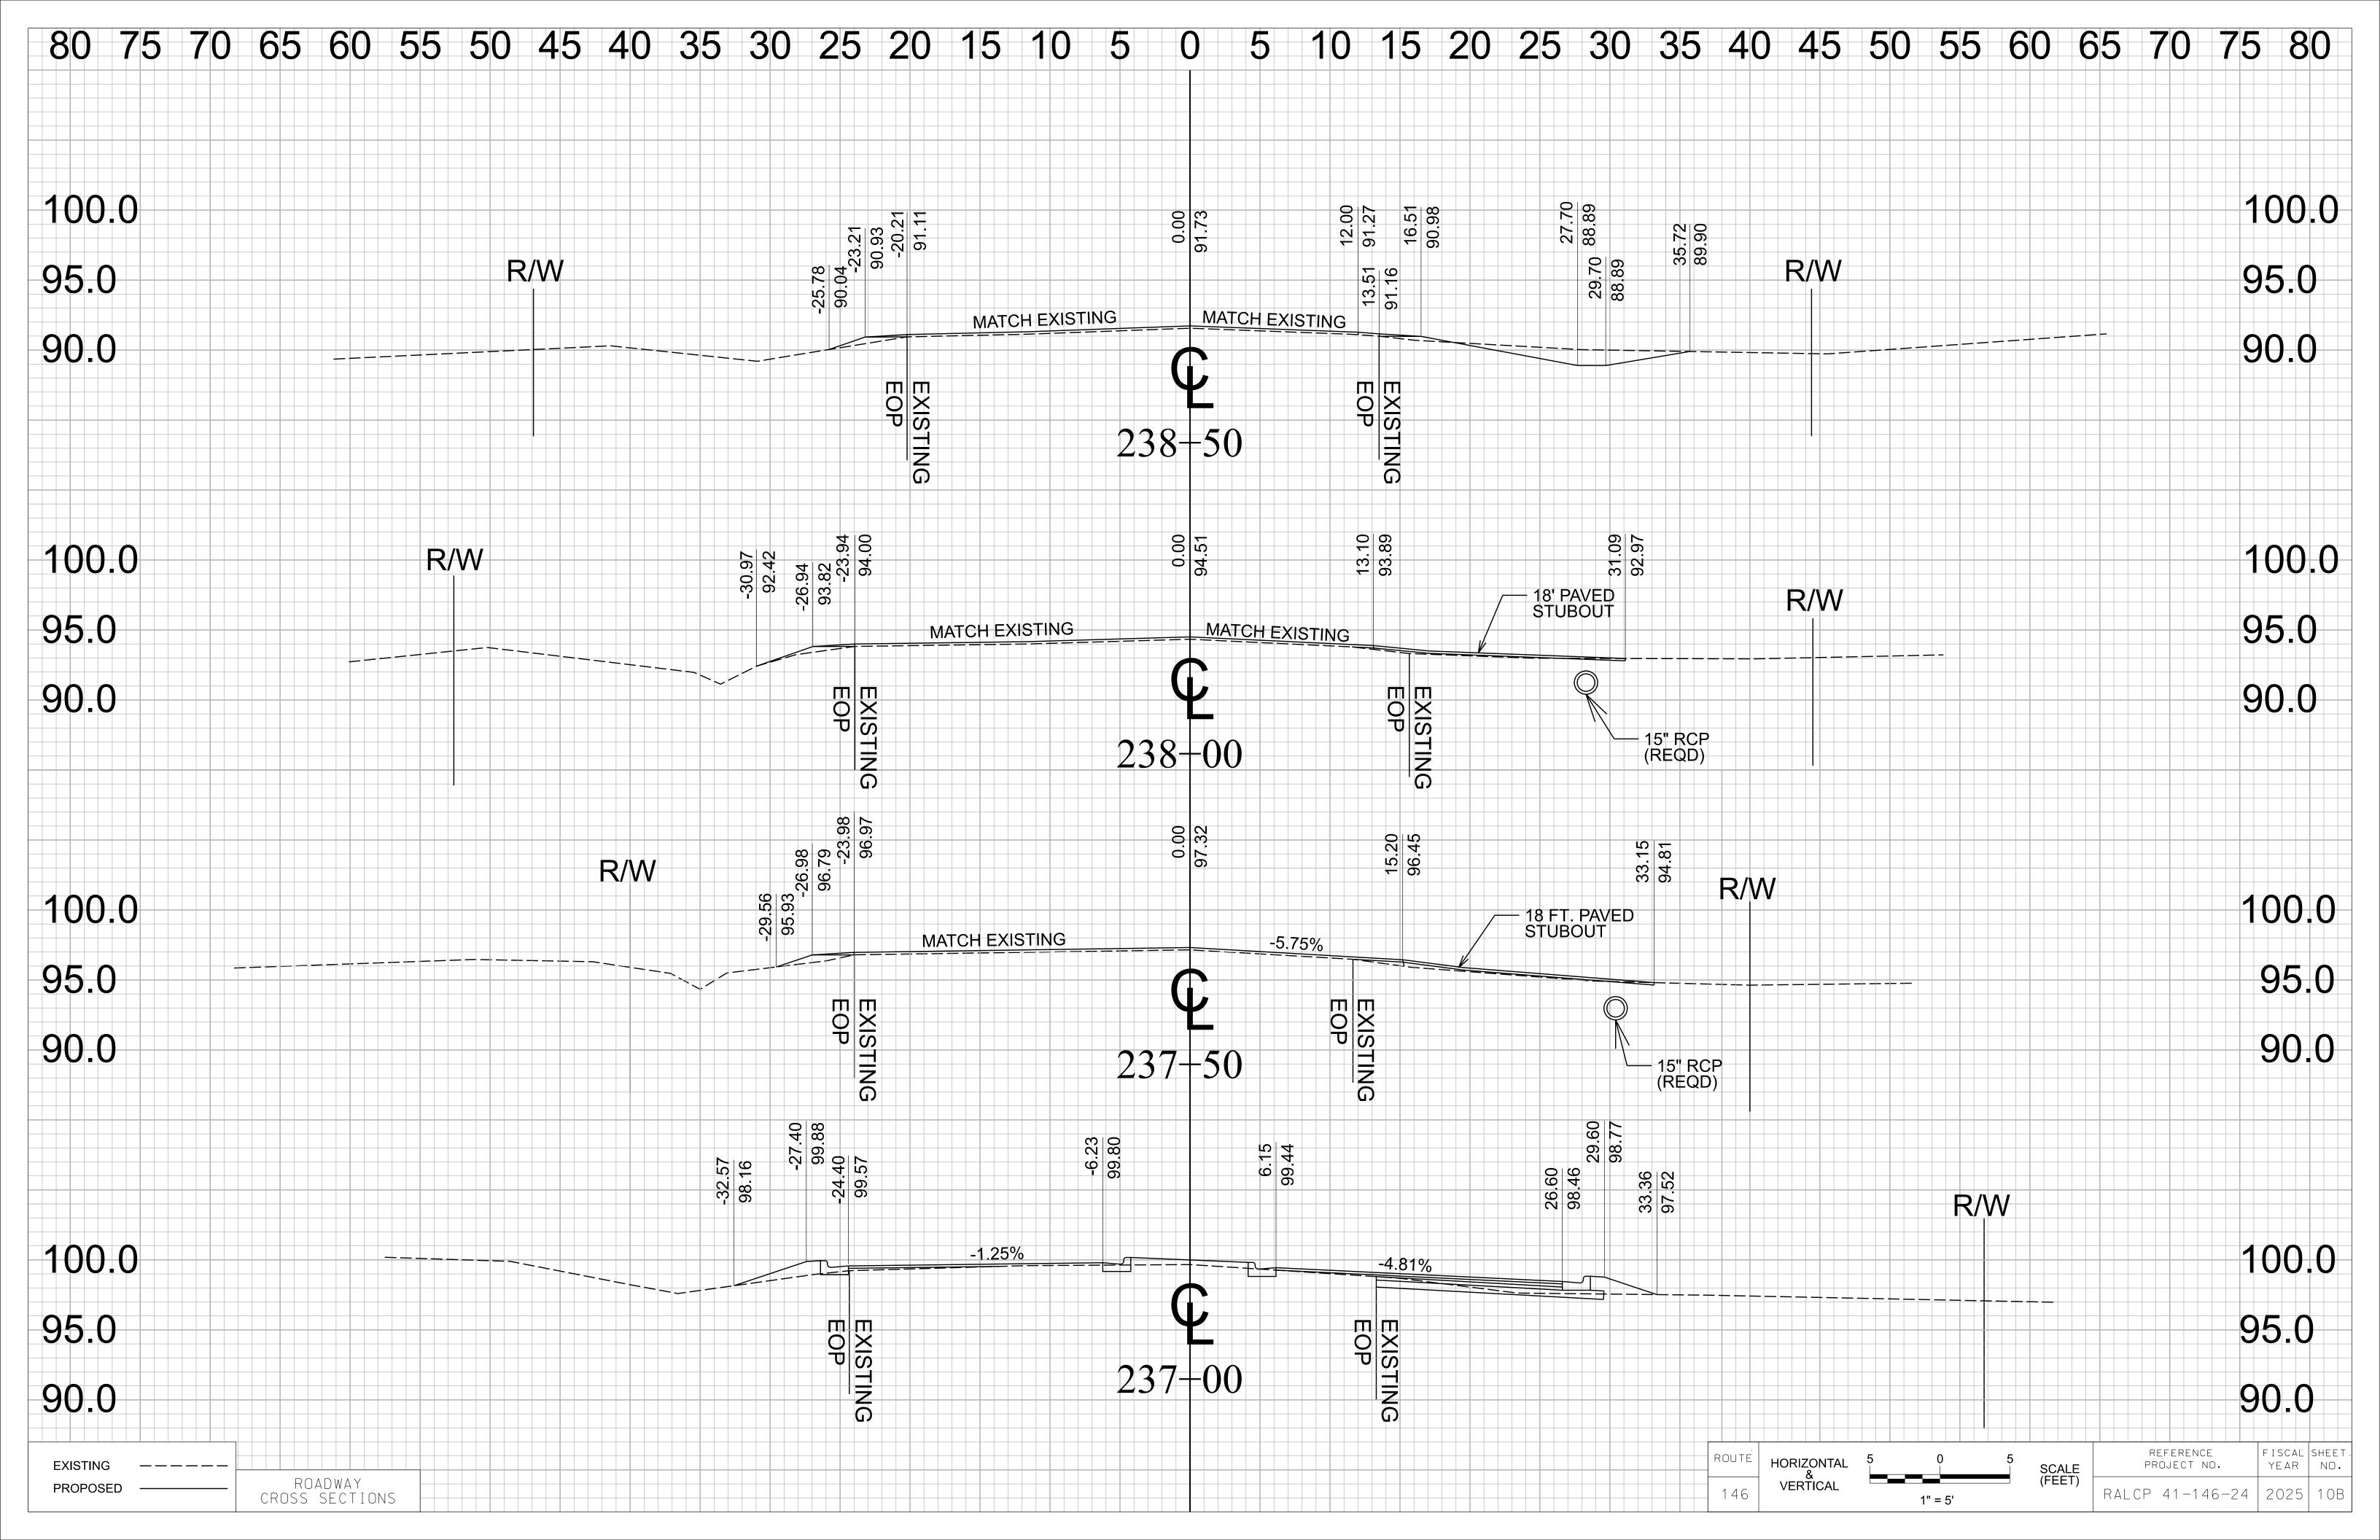

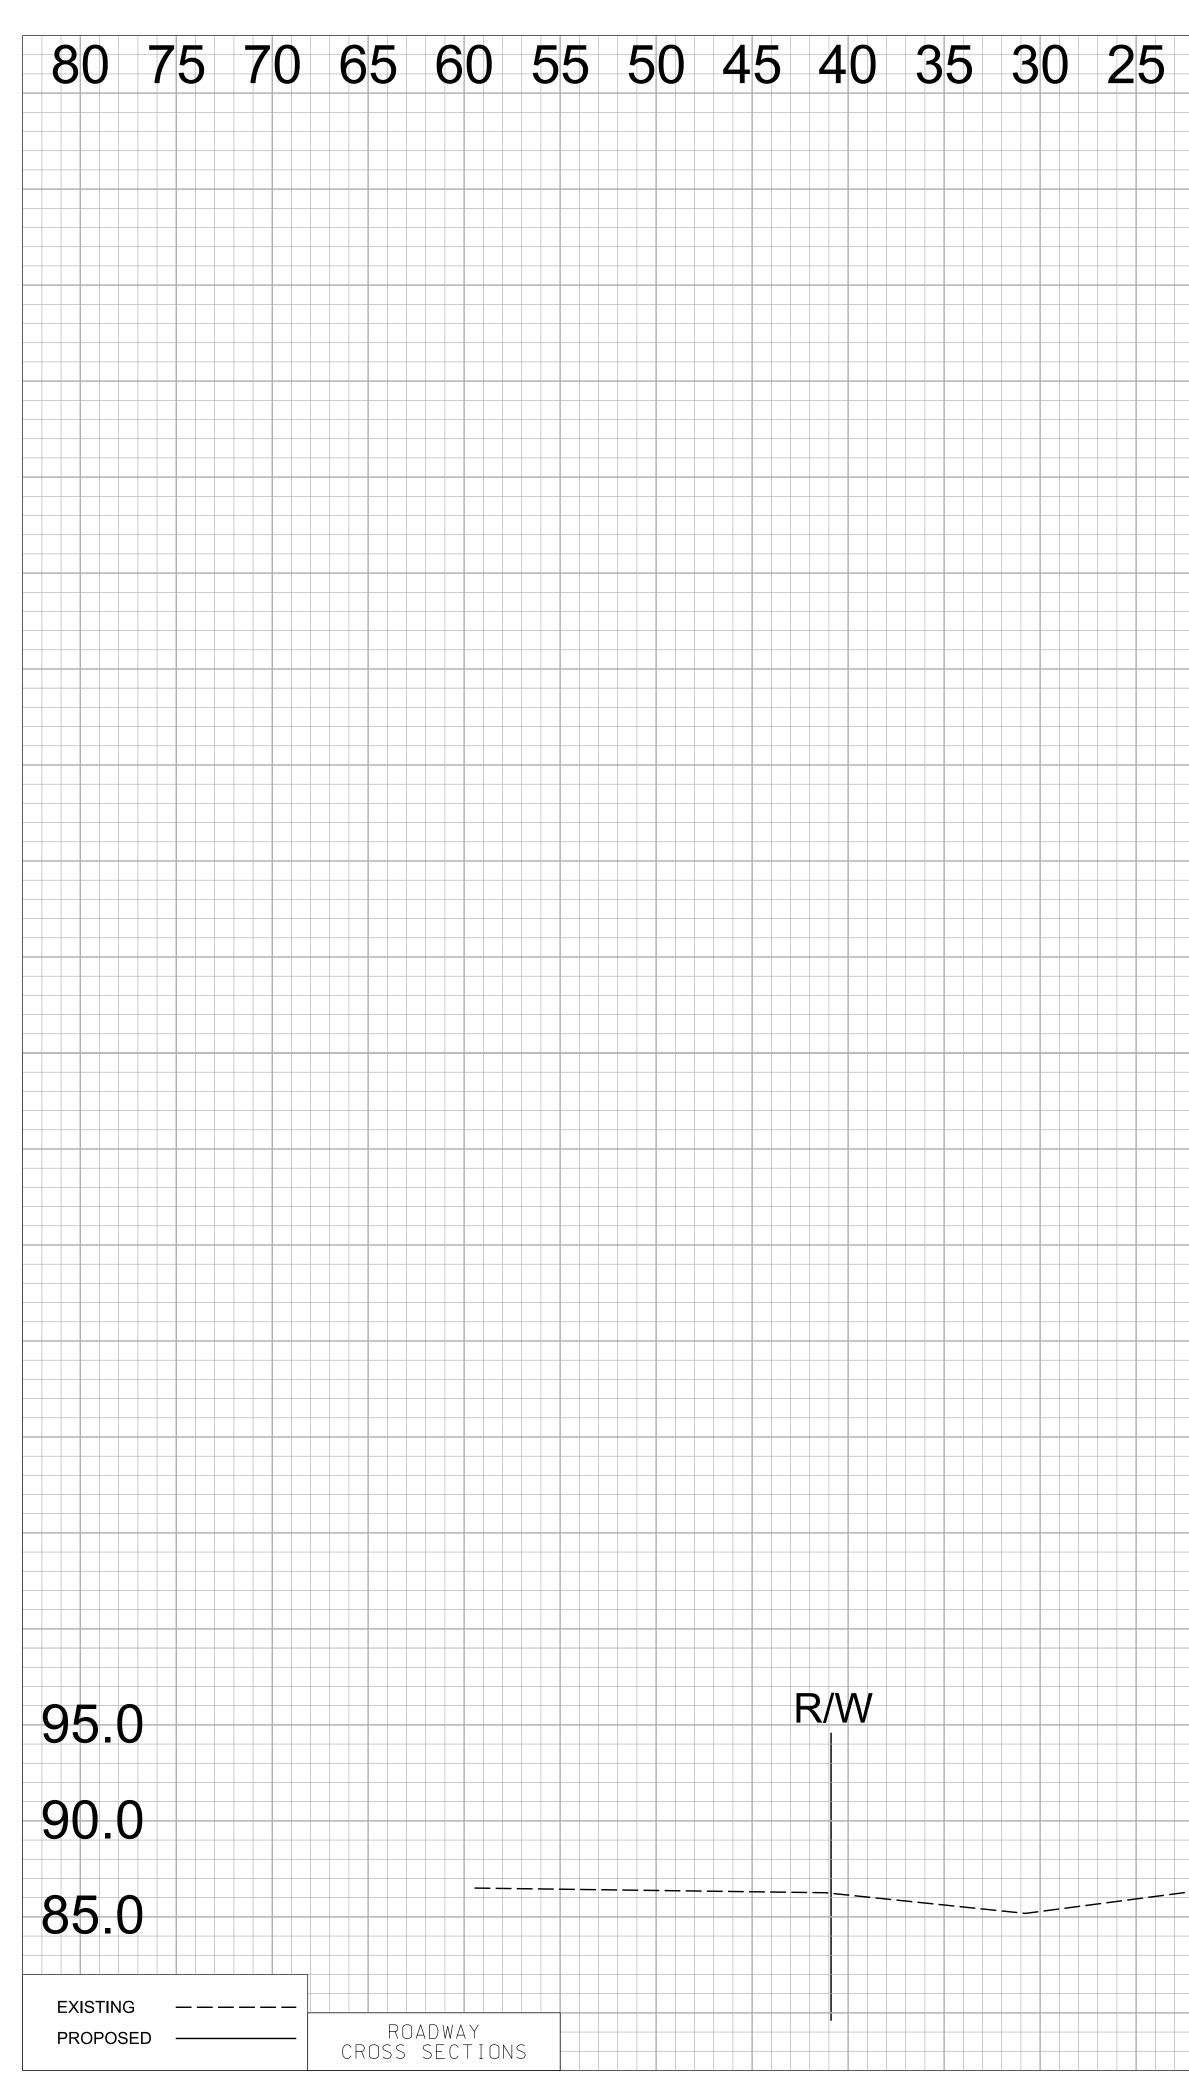

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